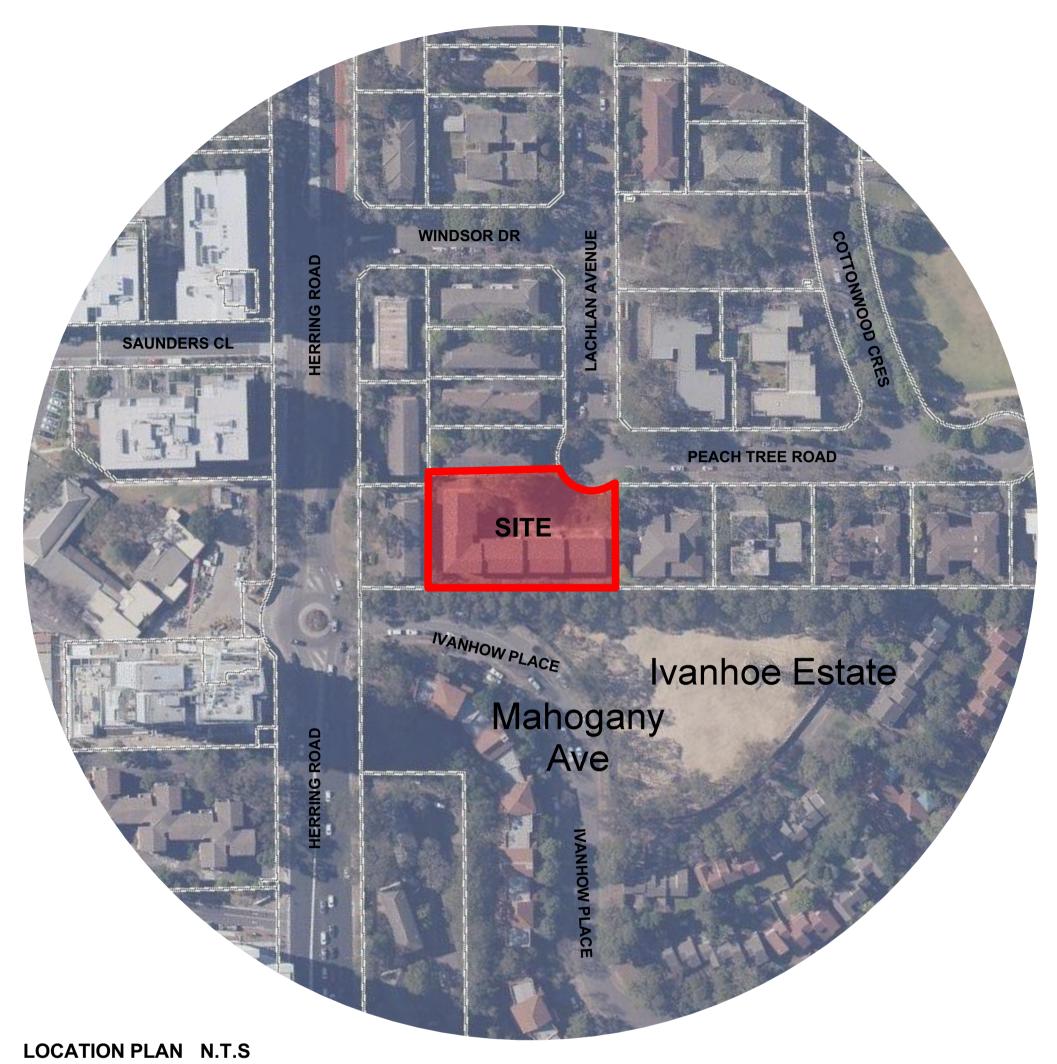
DEVELOPMENT APPLICATION 1-3 LACHLAN AVENUE, MACQUARIE PARK



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0000	COVER SHEET	
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1100	DEMOLITION PLAN	1:100
2000	BASEMENT FLOOR PLAN B2	1:100
2001	BASEMENT FLOOR PLAN B1	1:100
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3300	NEIGHBOURING BUILDING ENVELOPES	1:200
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6000	MATERIAL SCHEDULE	





7000 NOTIFICATION PLAN

CONTROL TABLE

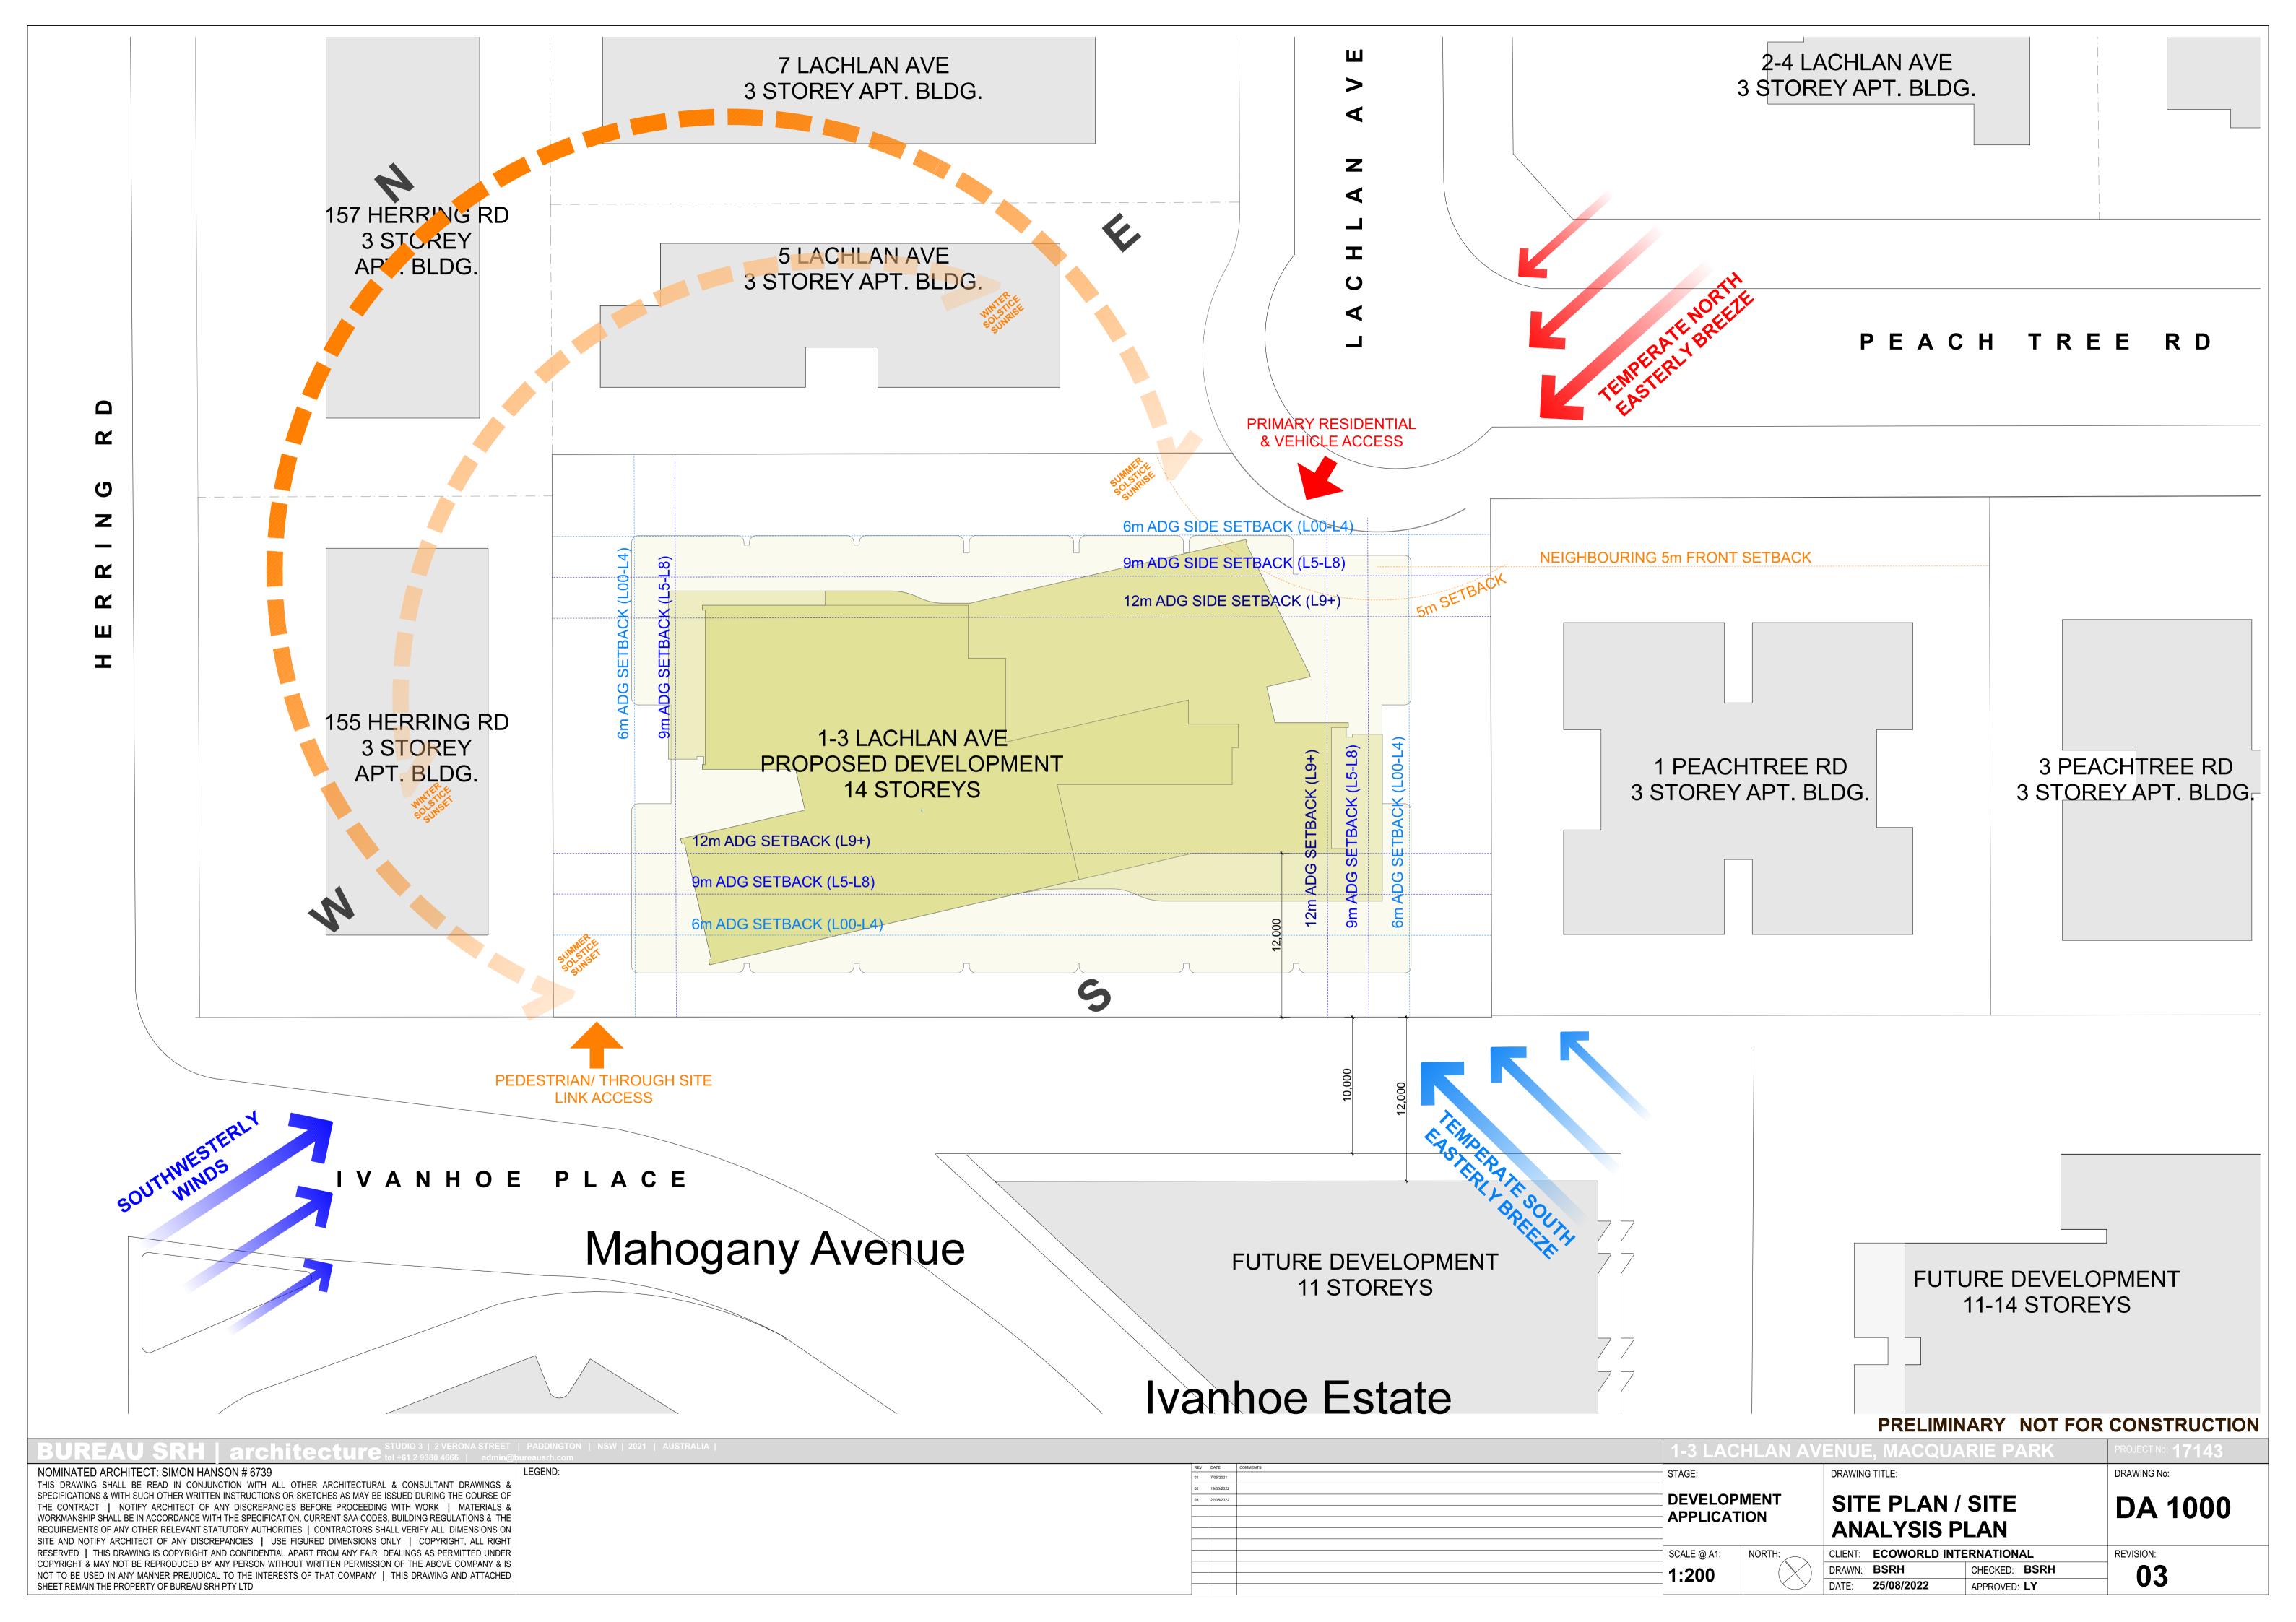
SITE AREA 2751m²

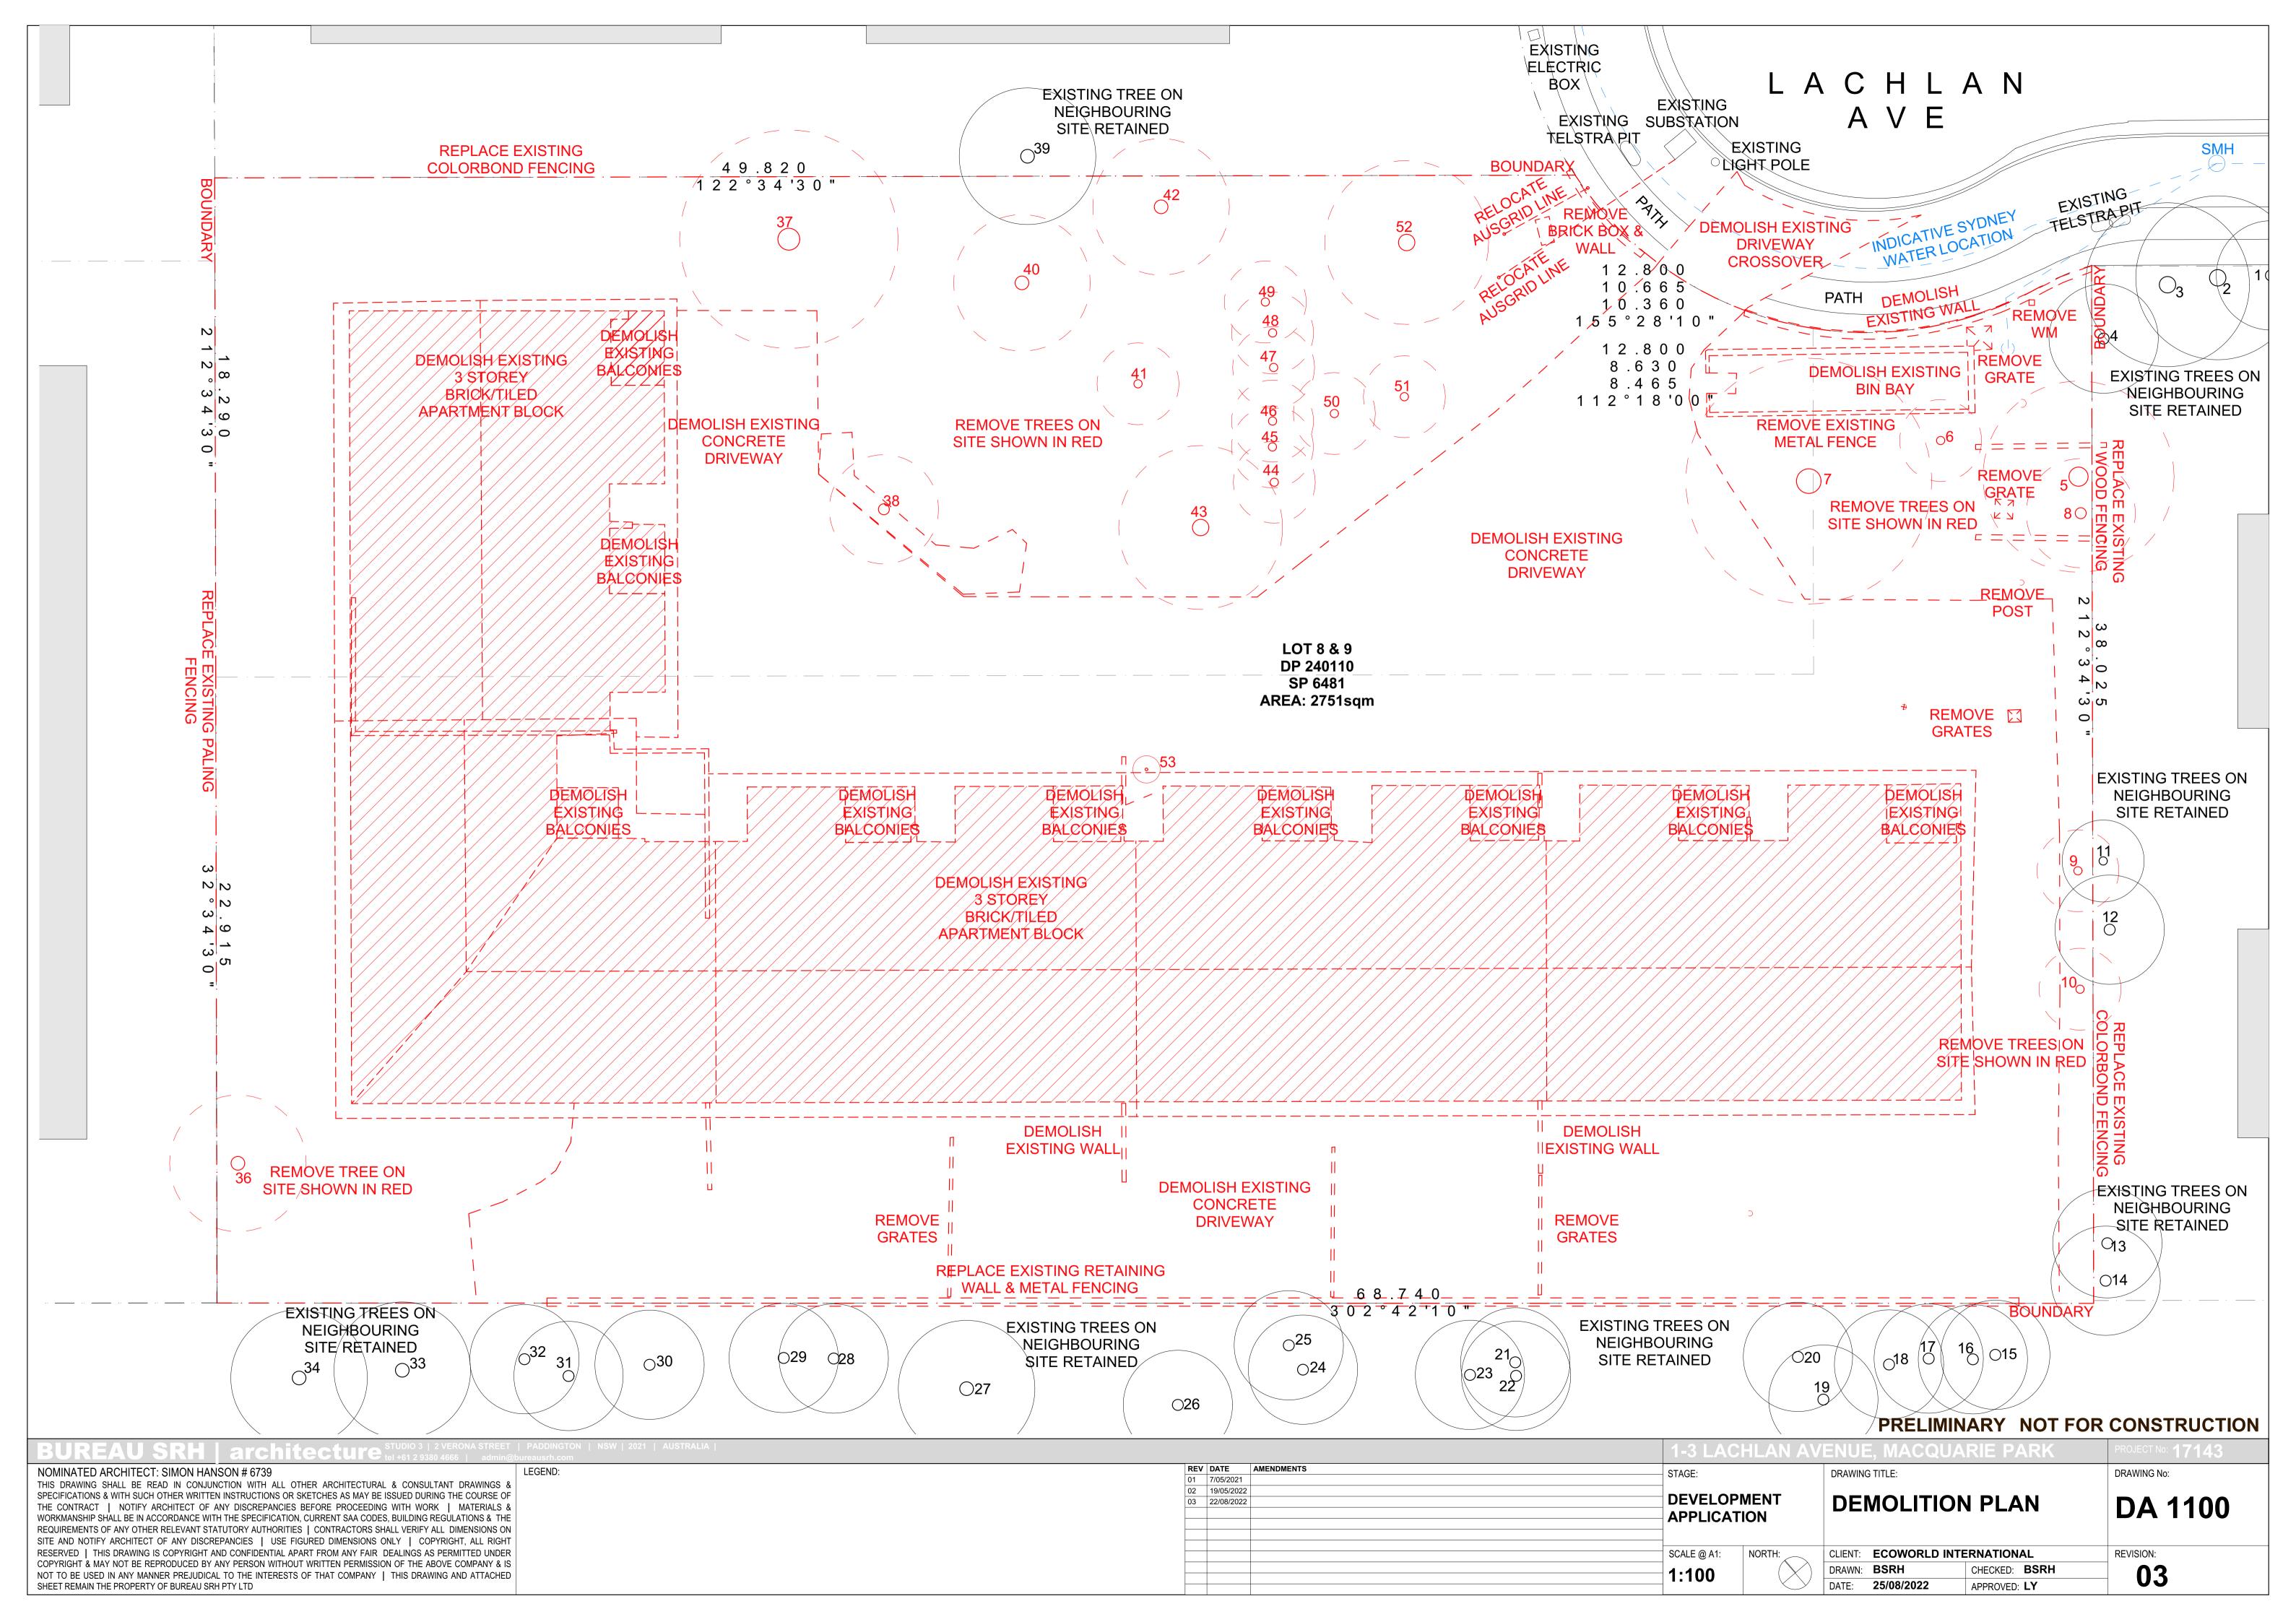
UNIT MIX

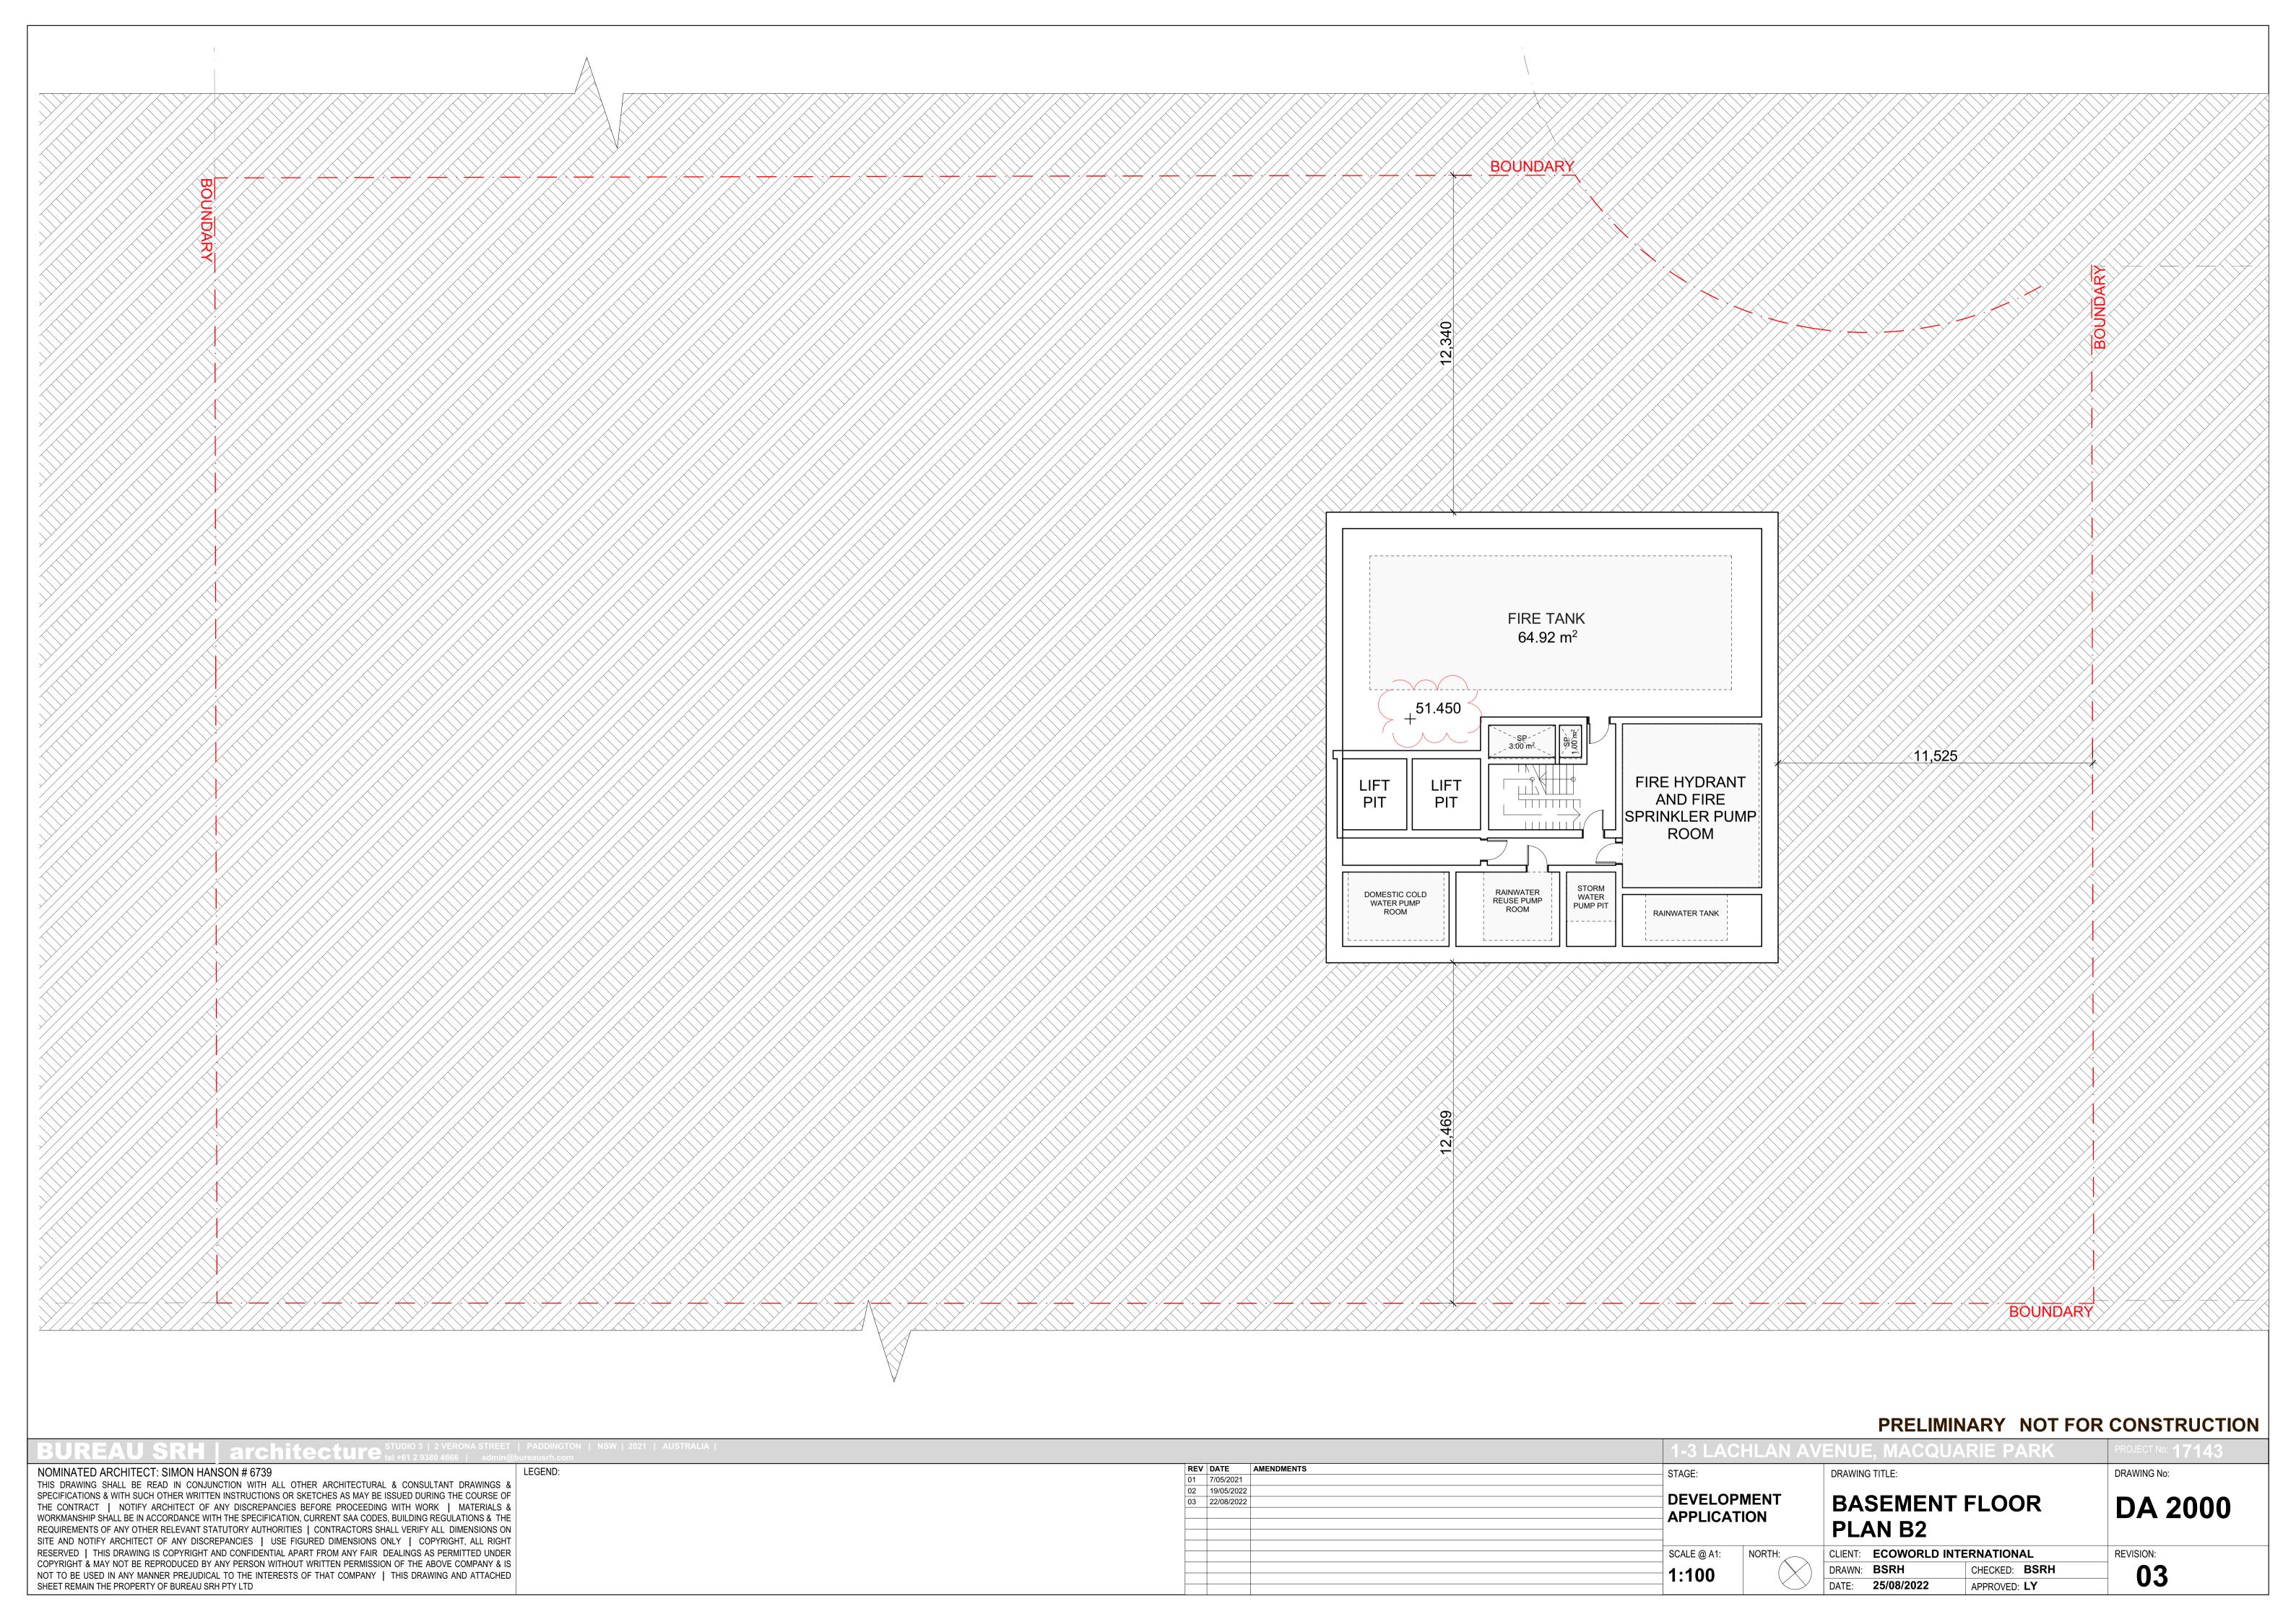
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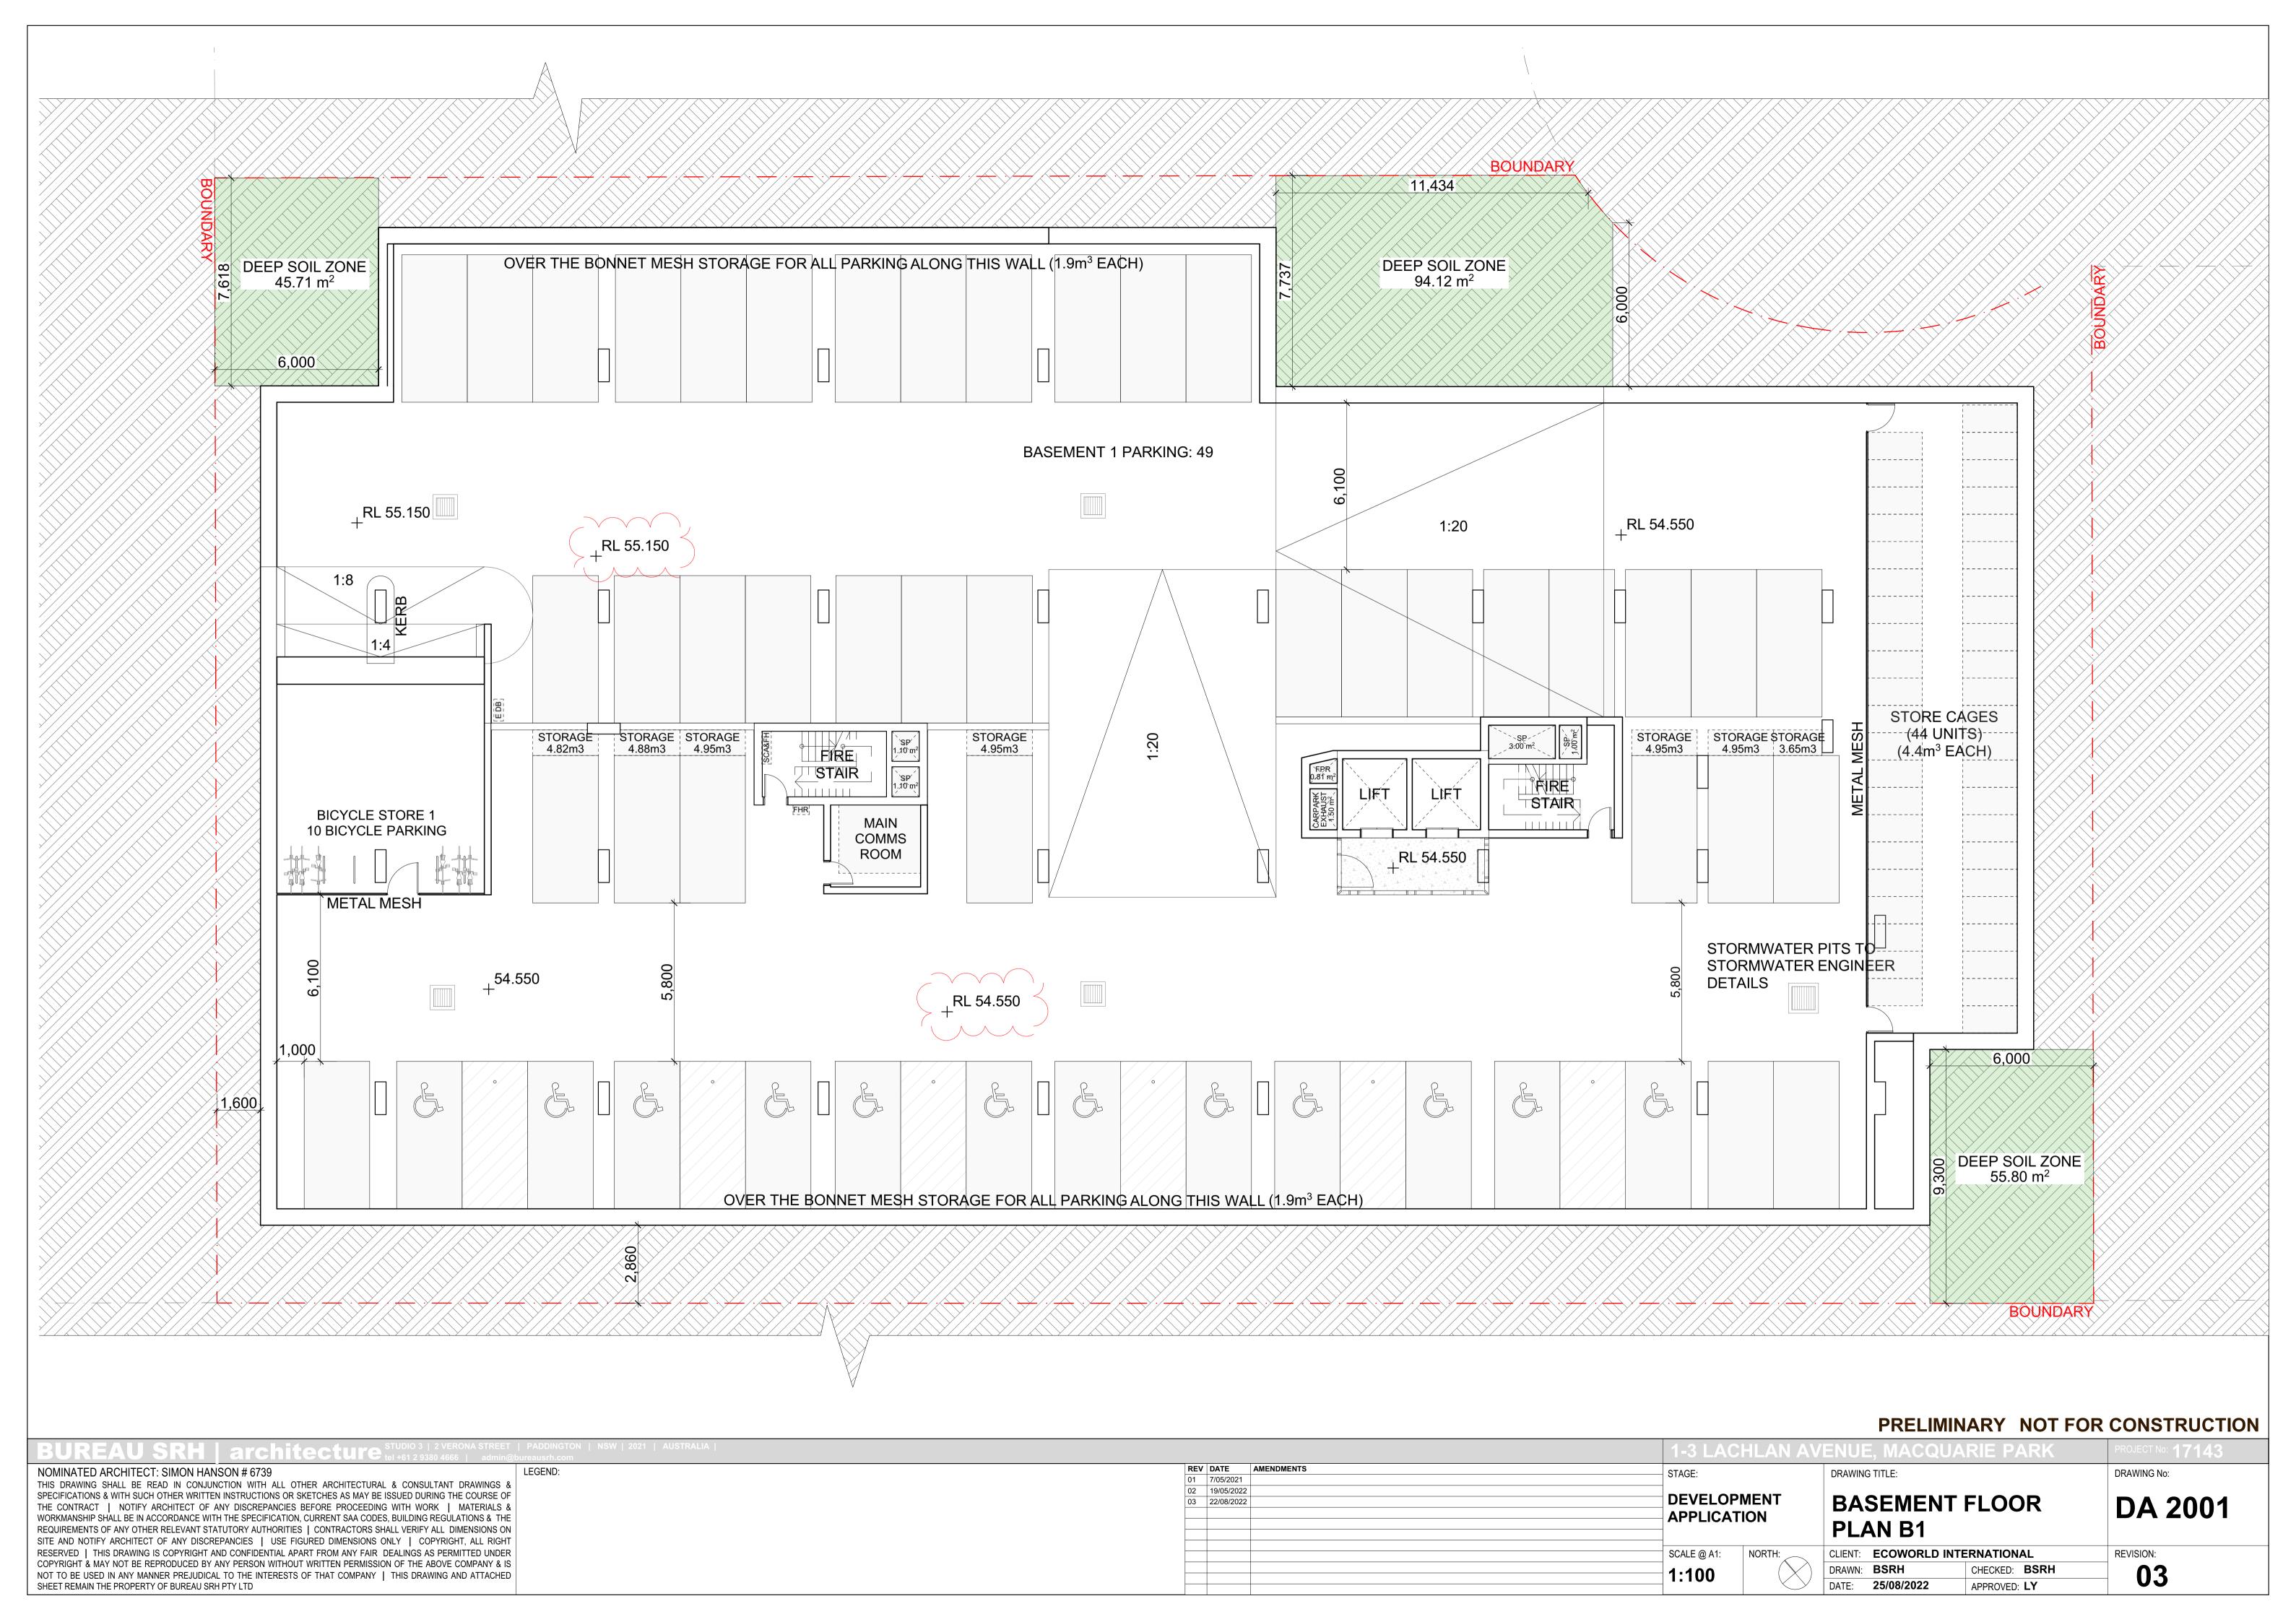
SUBTO	`	123
3BED	16 (13	3%)
2BED	63 (51	%)
1BED	44 (36	5%)

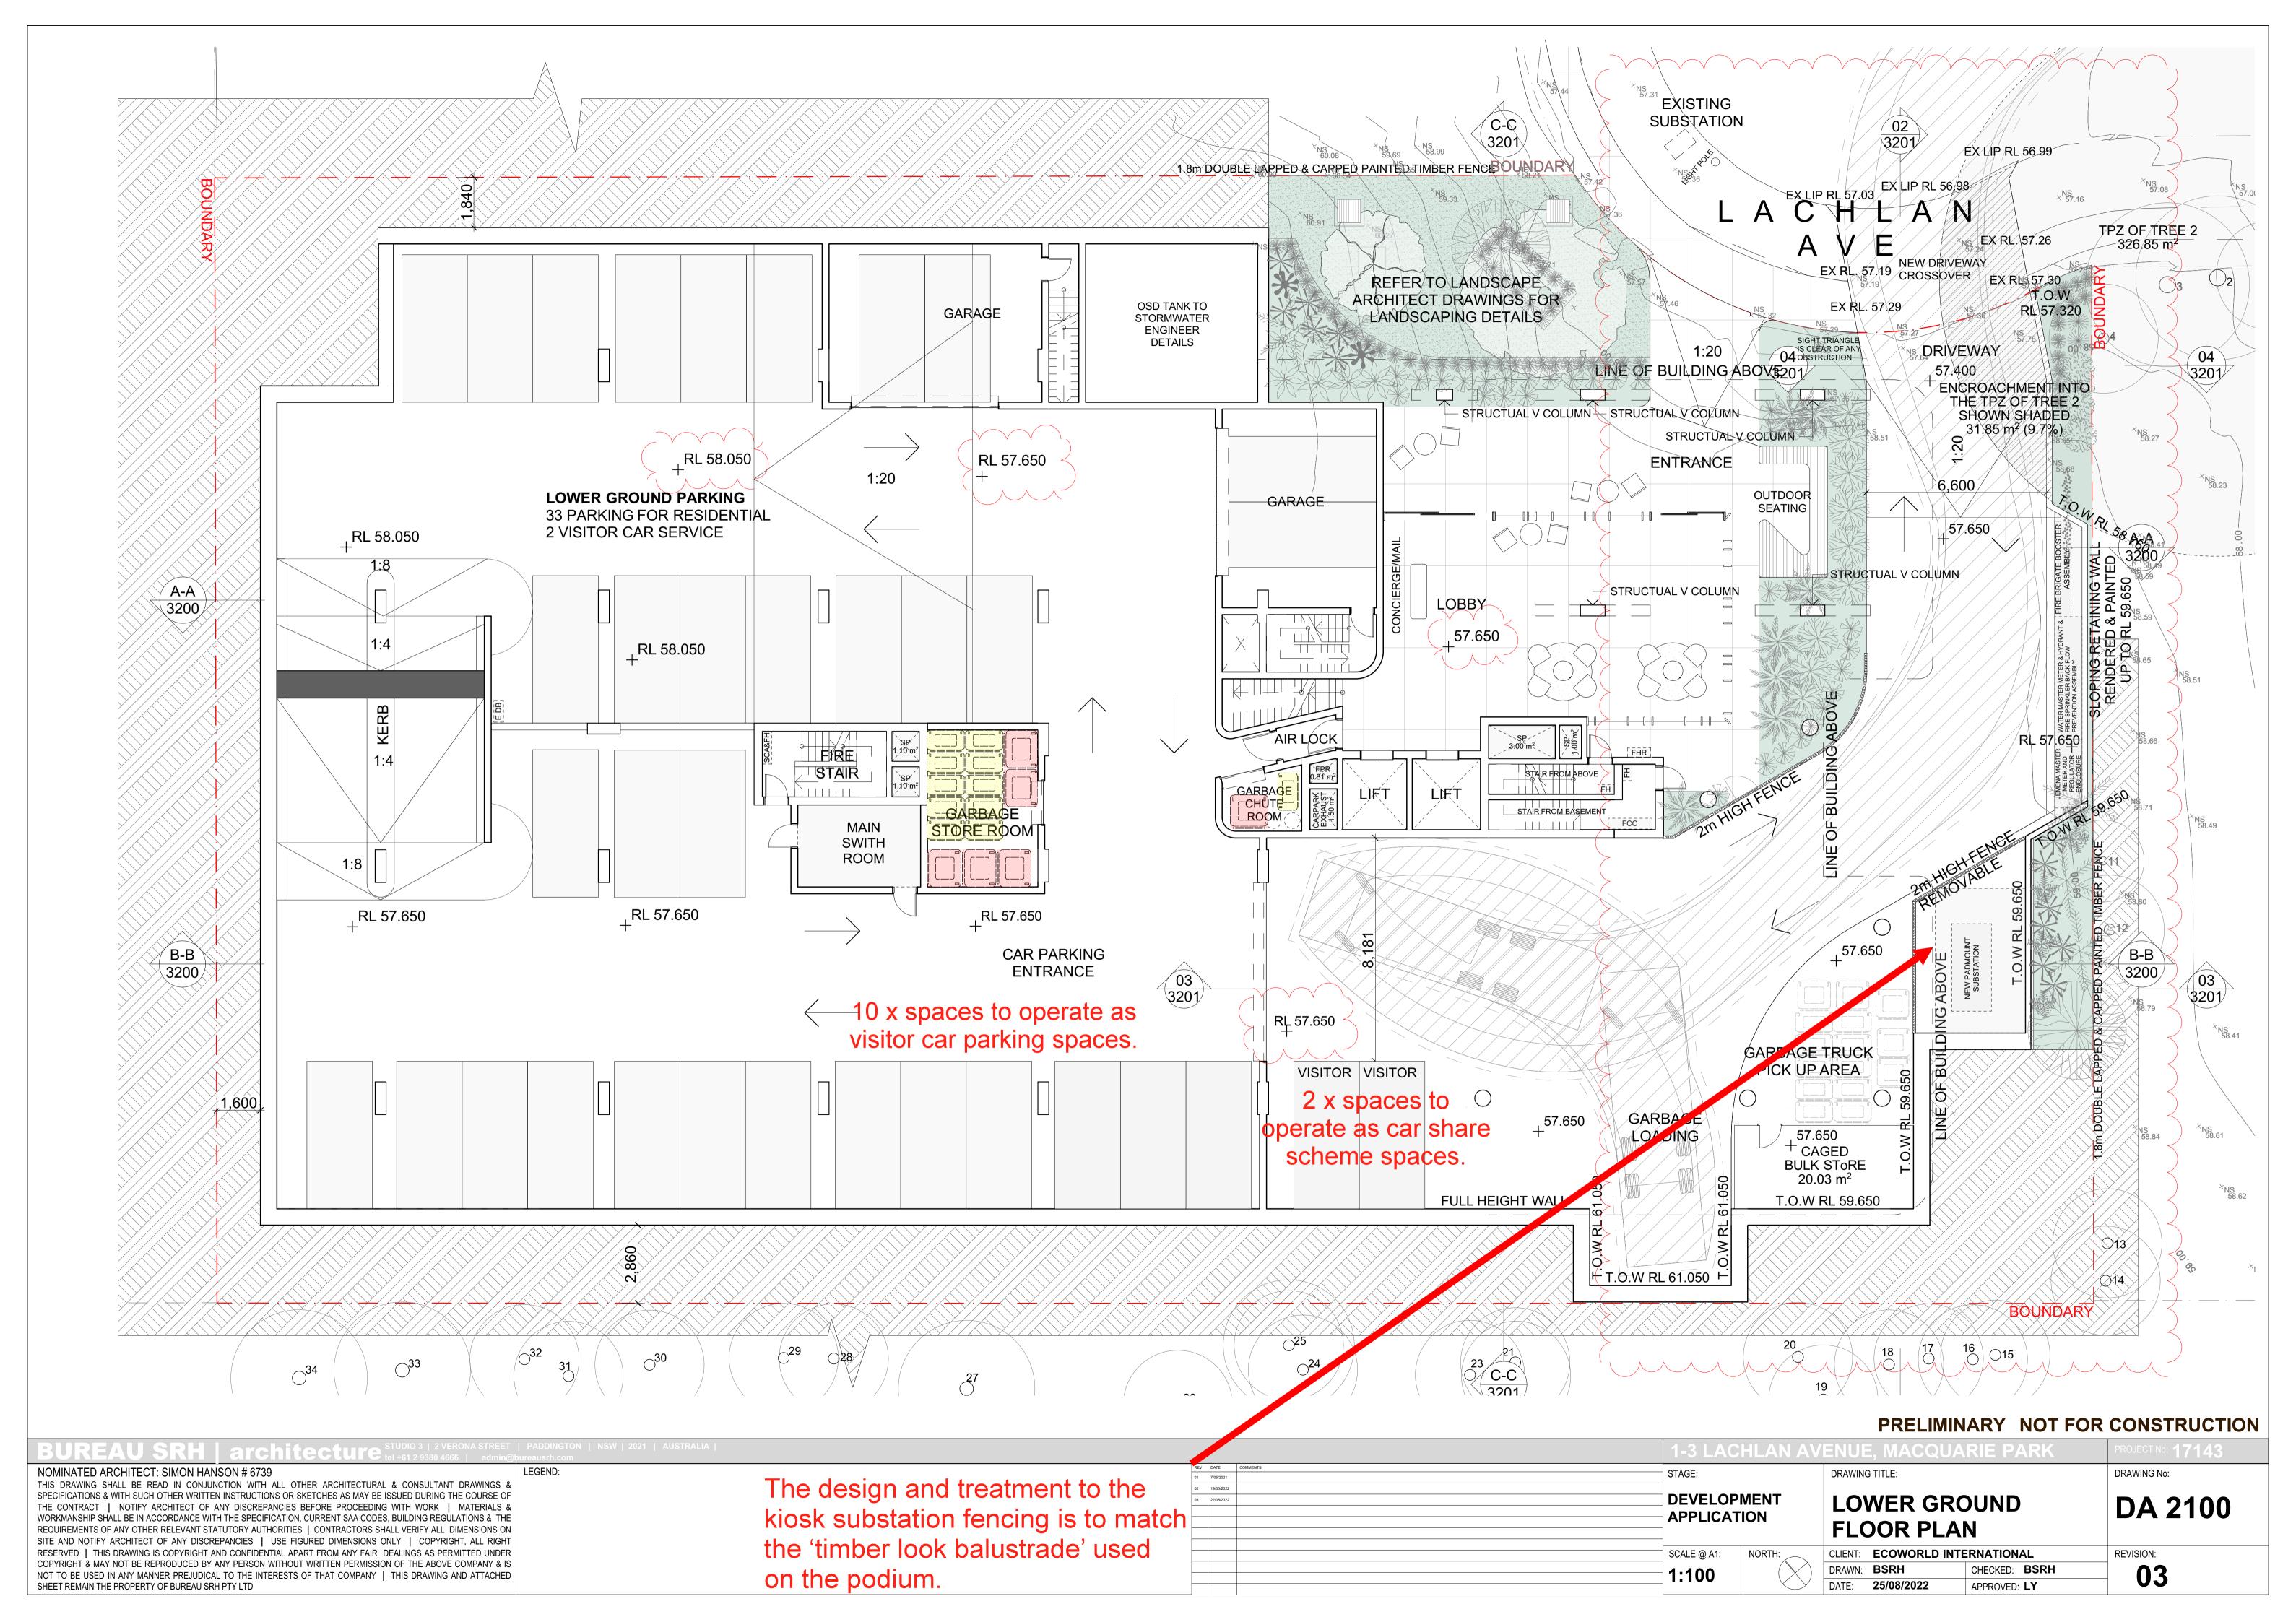
	REQUIRED	PROPOSED
FSR	4:1 (11,004m²)	4:1 (11,003.84m ²)
HEIGHT	45m	47.83m
COMMUNAL OPEN SPACE	25% OF SITE	30.8% OF SITE (847.61m ²)
DEEP SOIL	7% (193m²)	7.1% (195.63m²)
SOLAR	70%	70.7% (87/123)
VENTILATION	60% FOR FIRST 9 STOREY	64.4% (47/73)
CAR PARKING	MAX 112	105 + 2 VISITORS
BICYCLE PARKING	12	Min.15

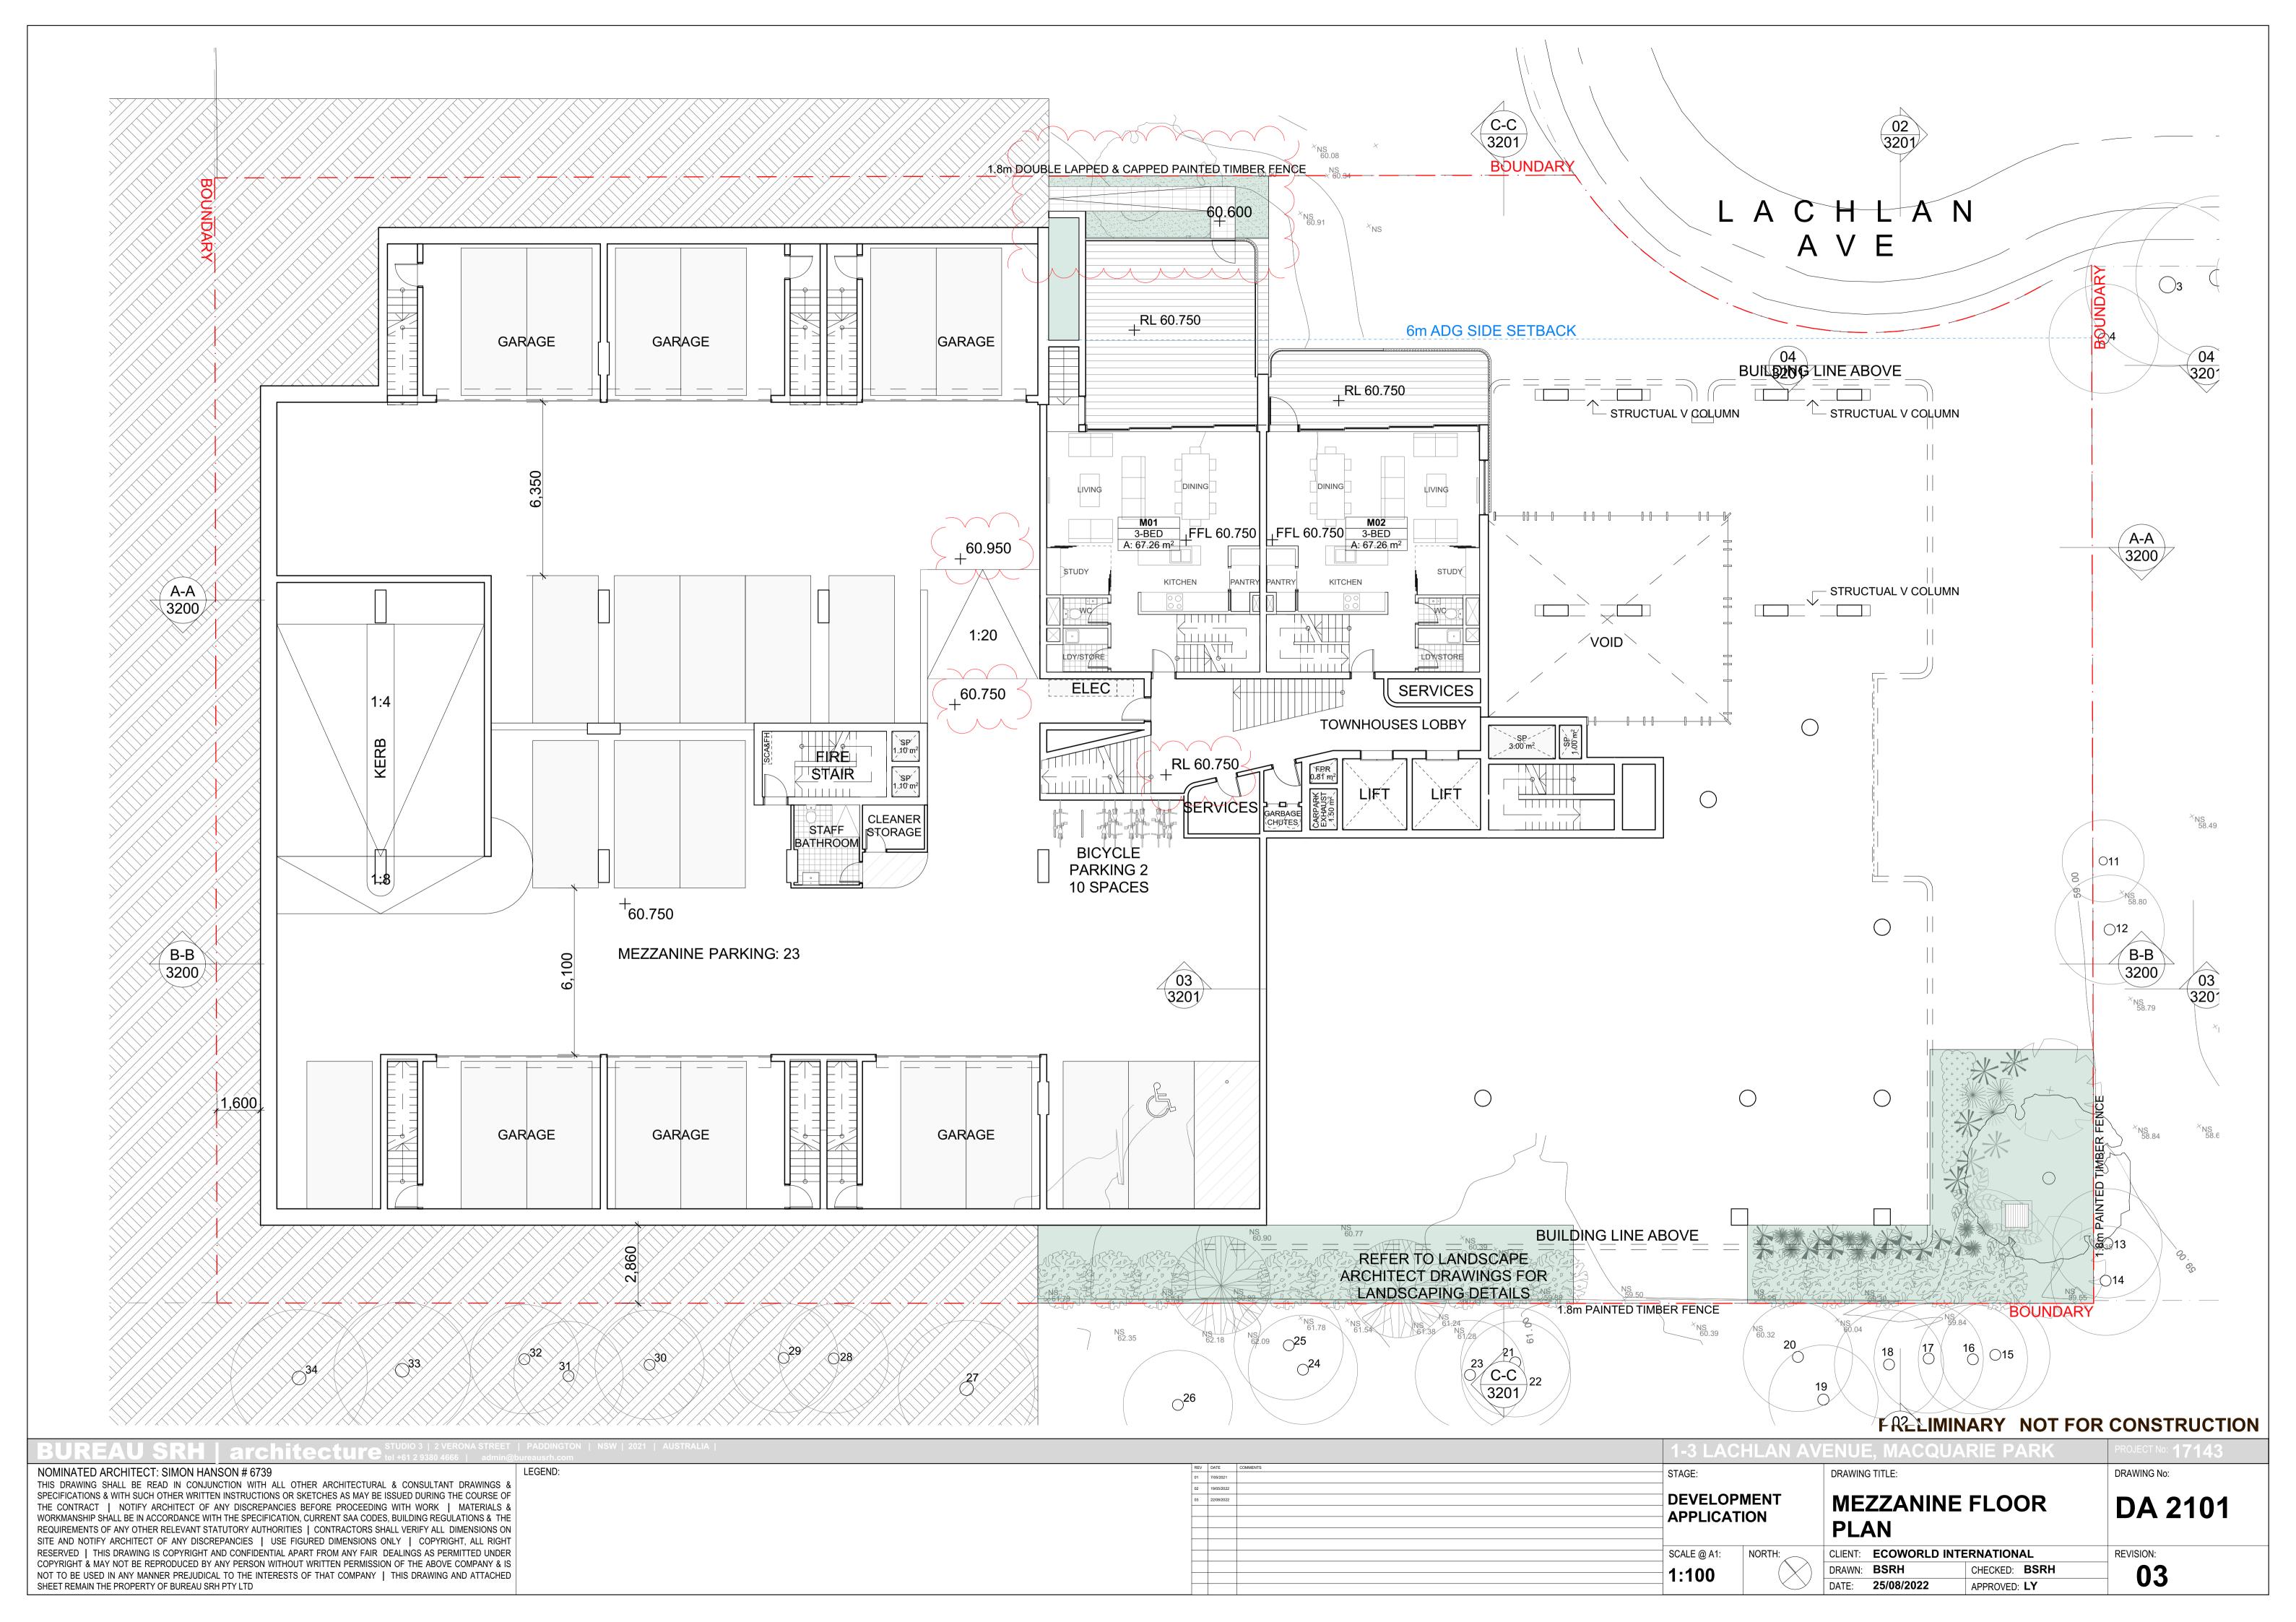


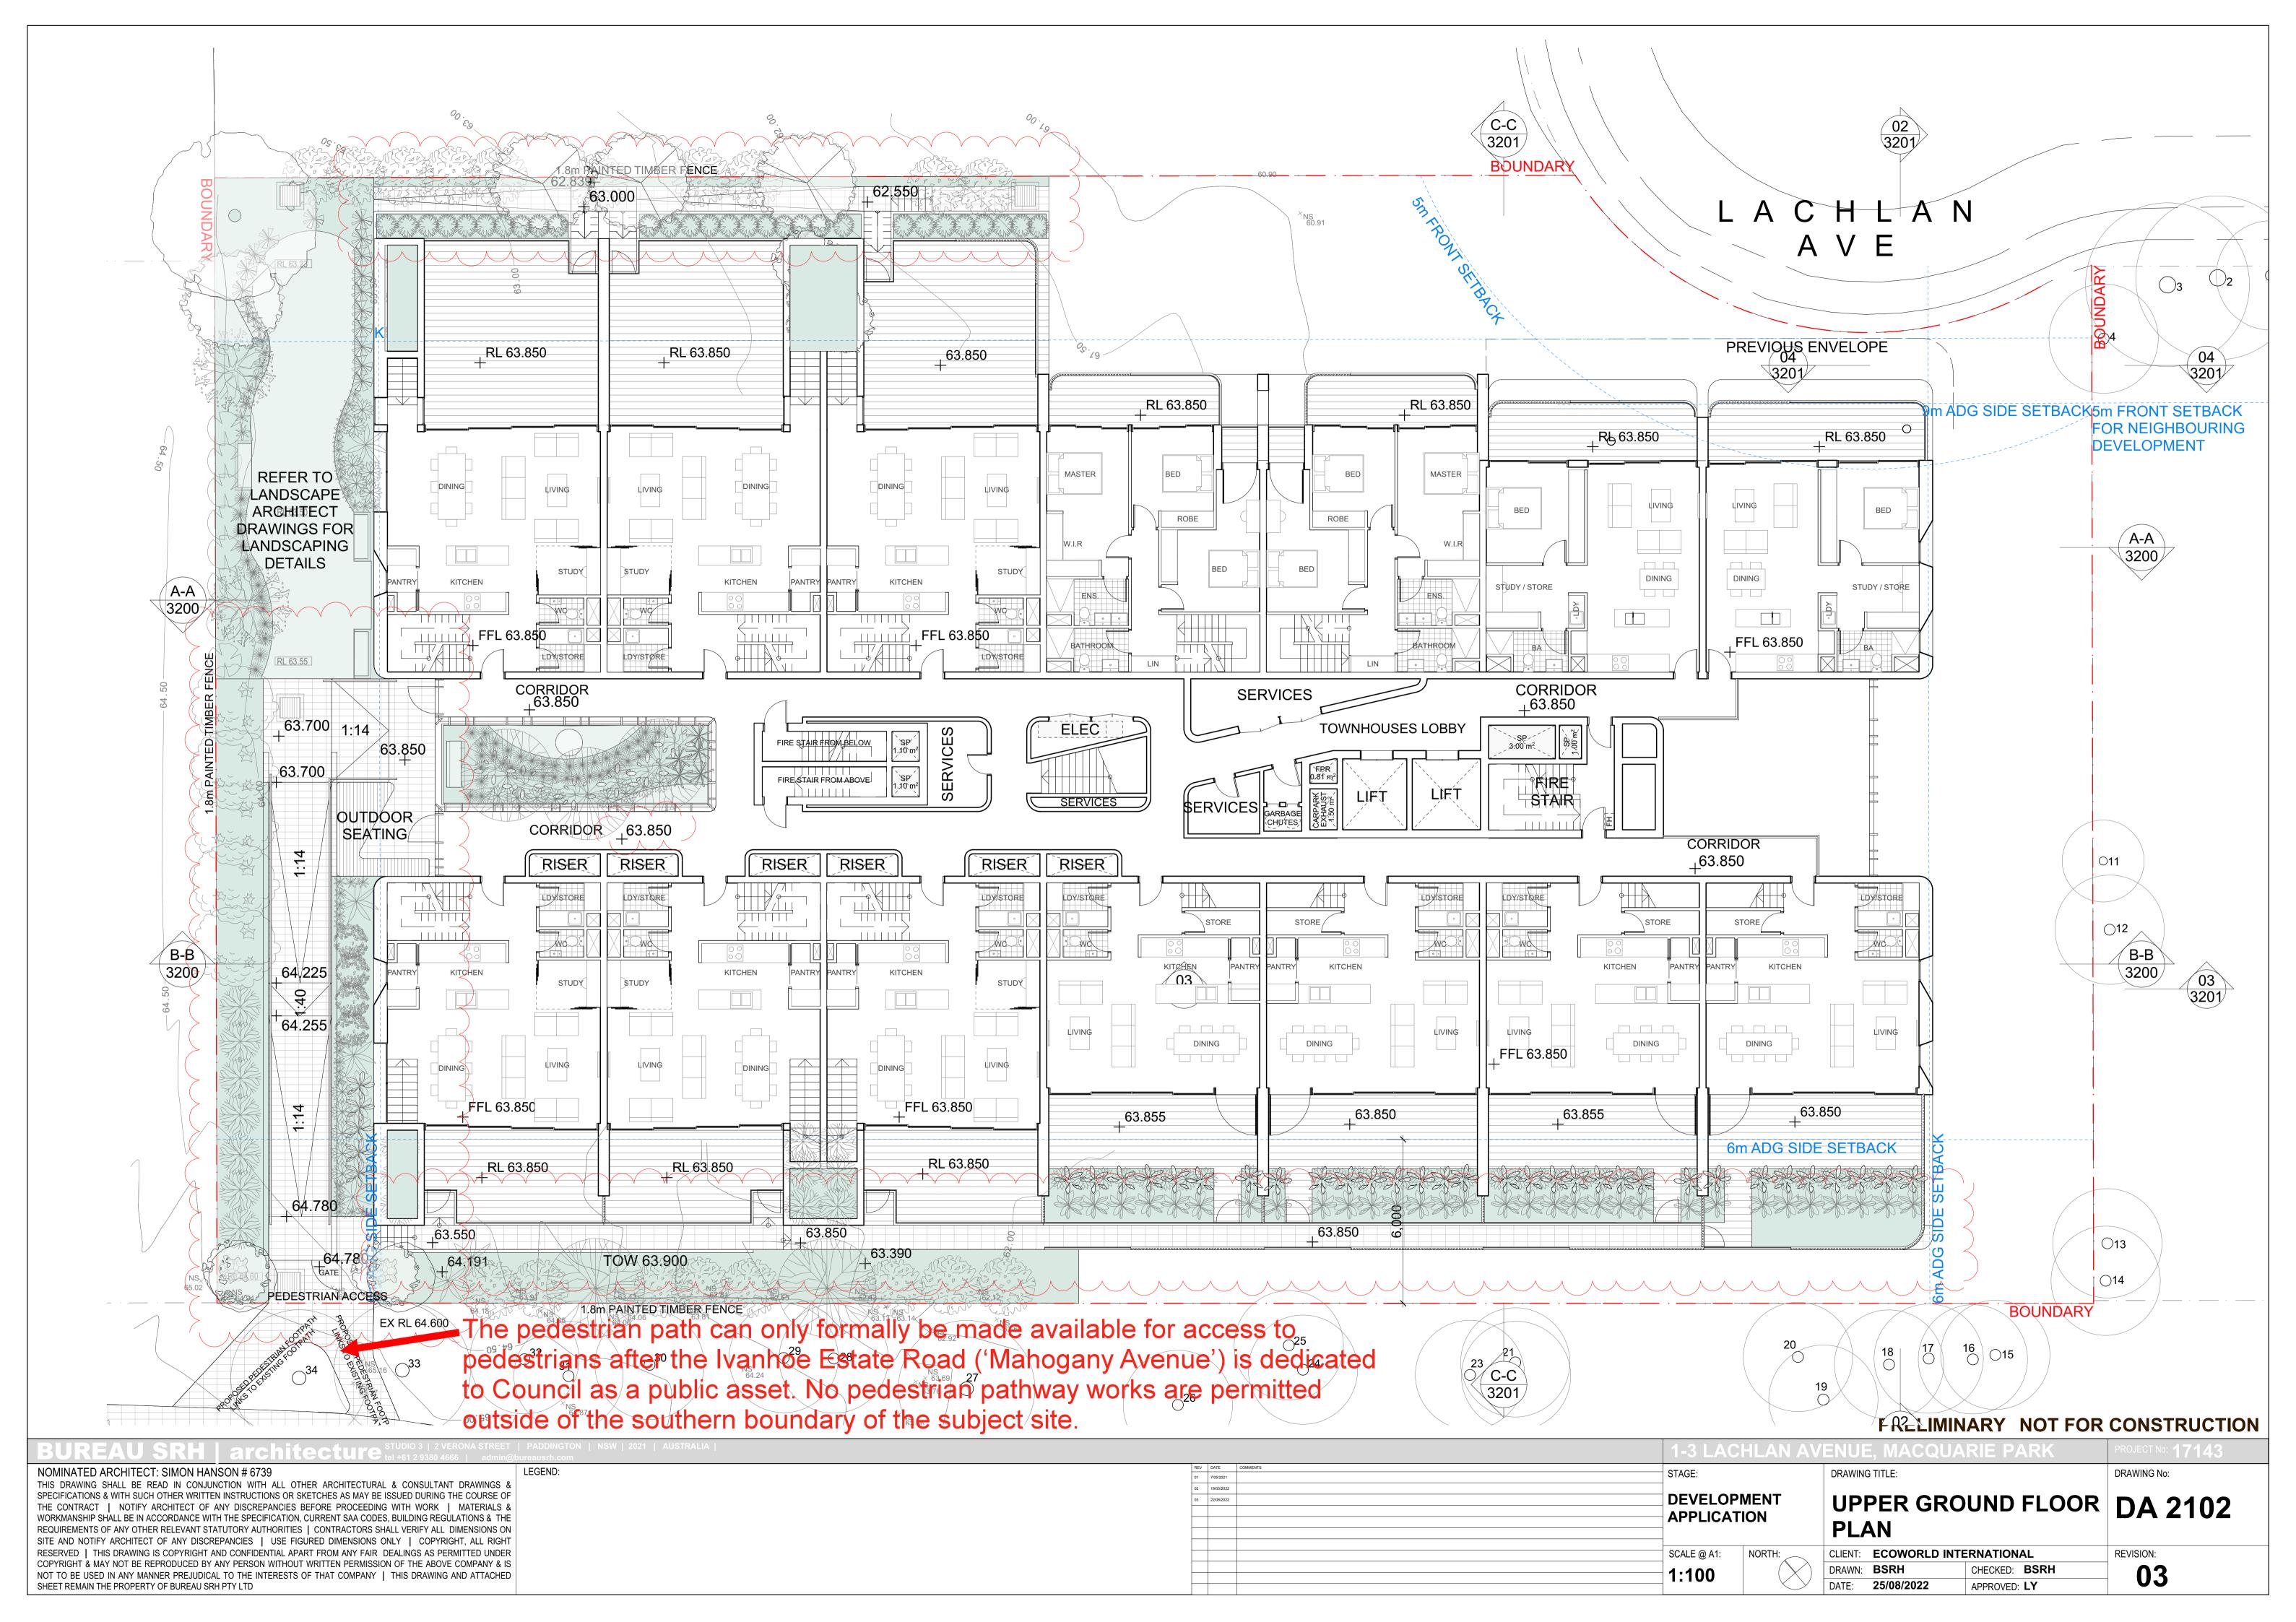


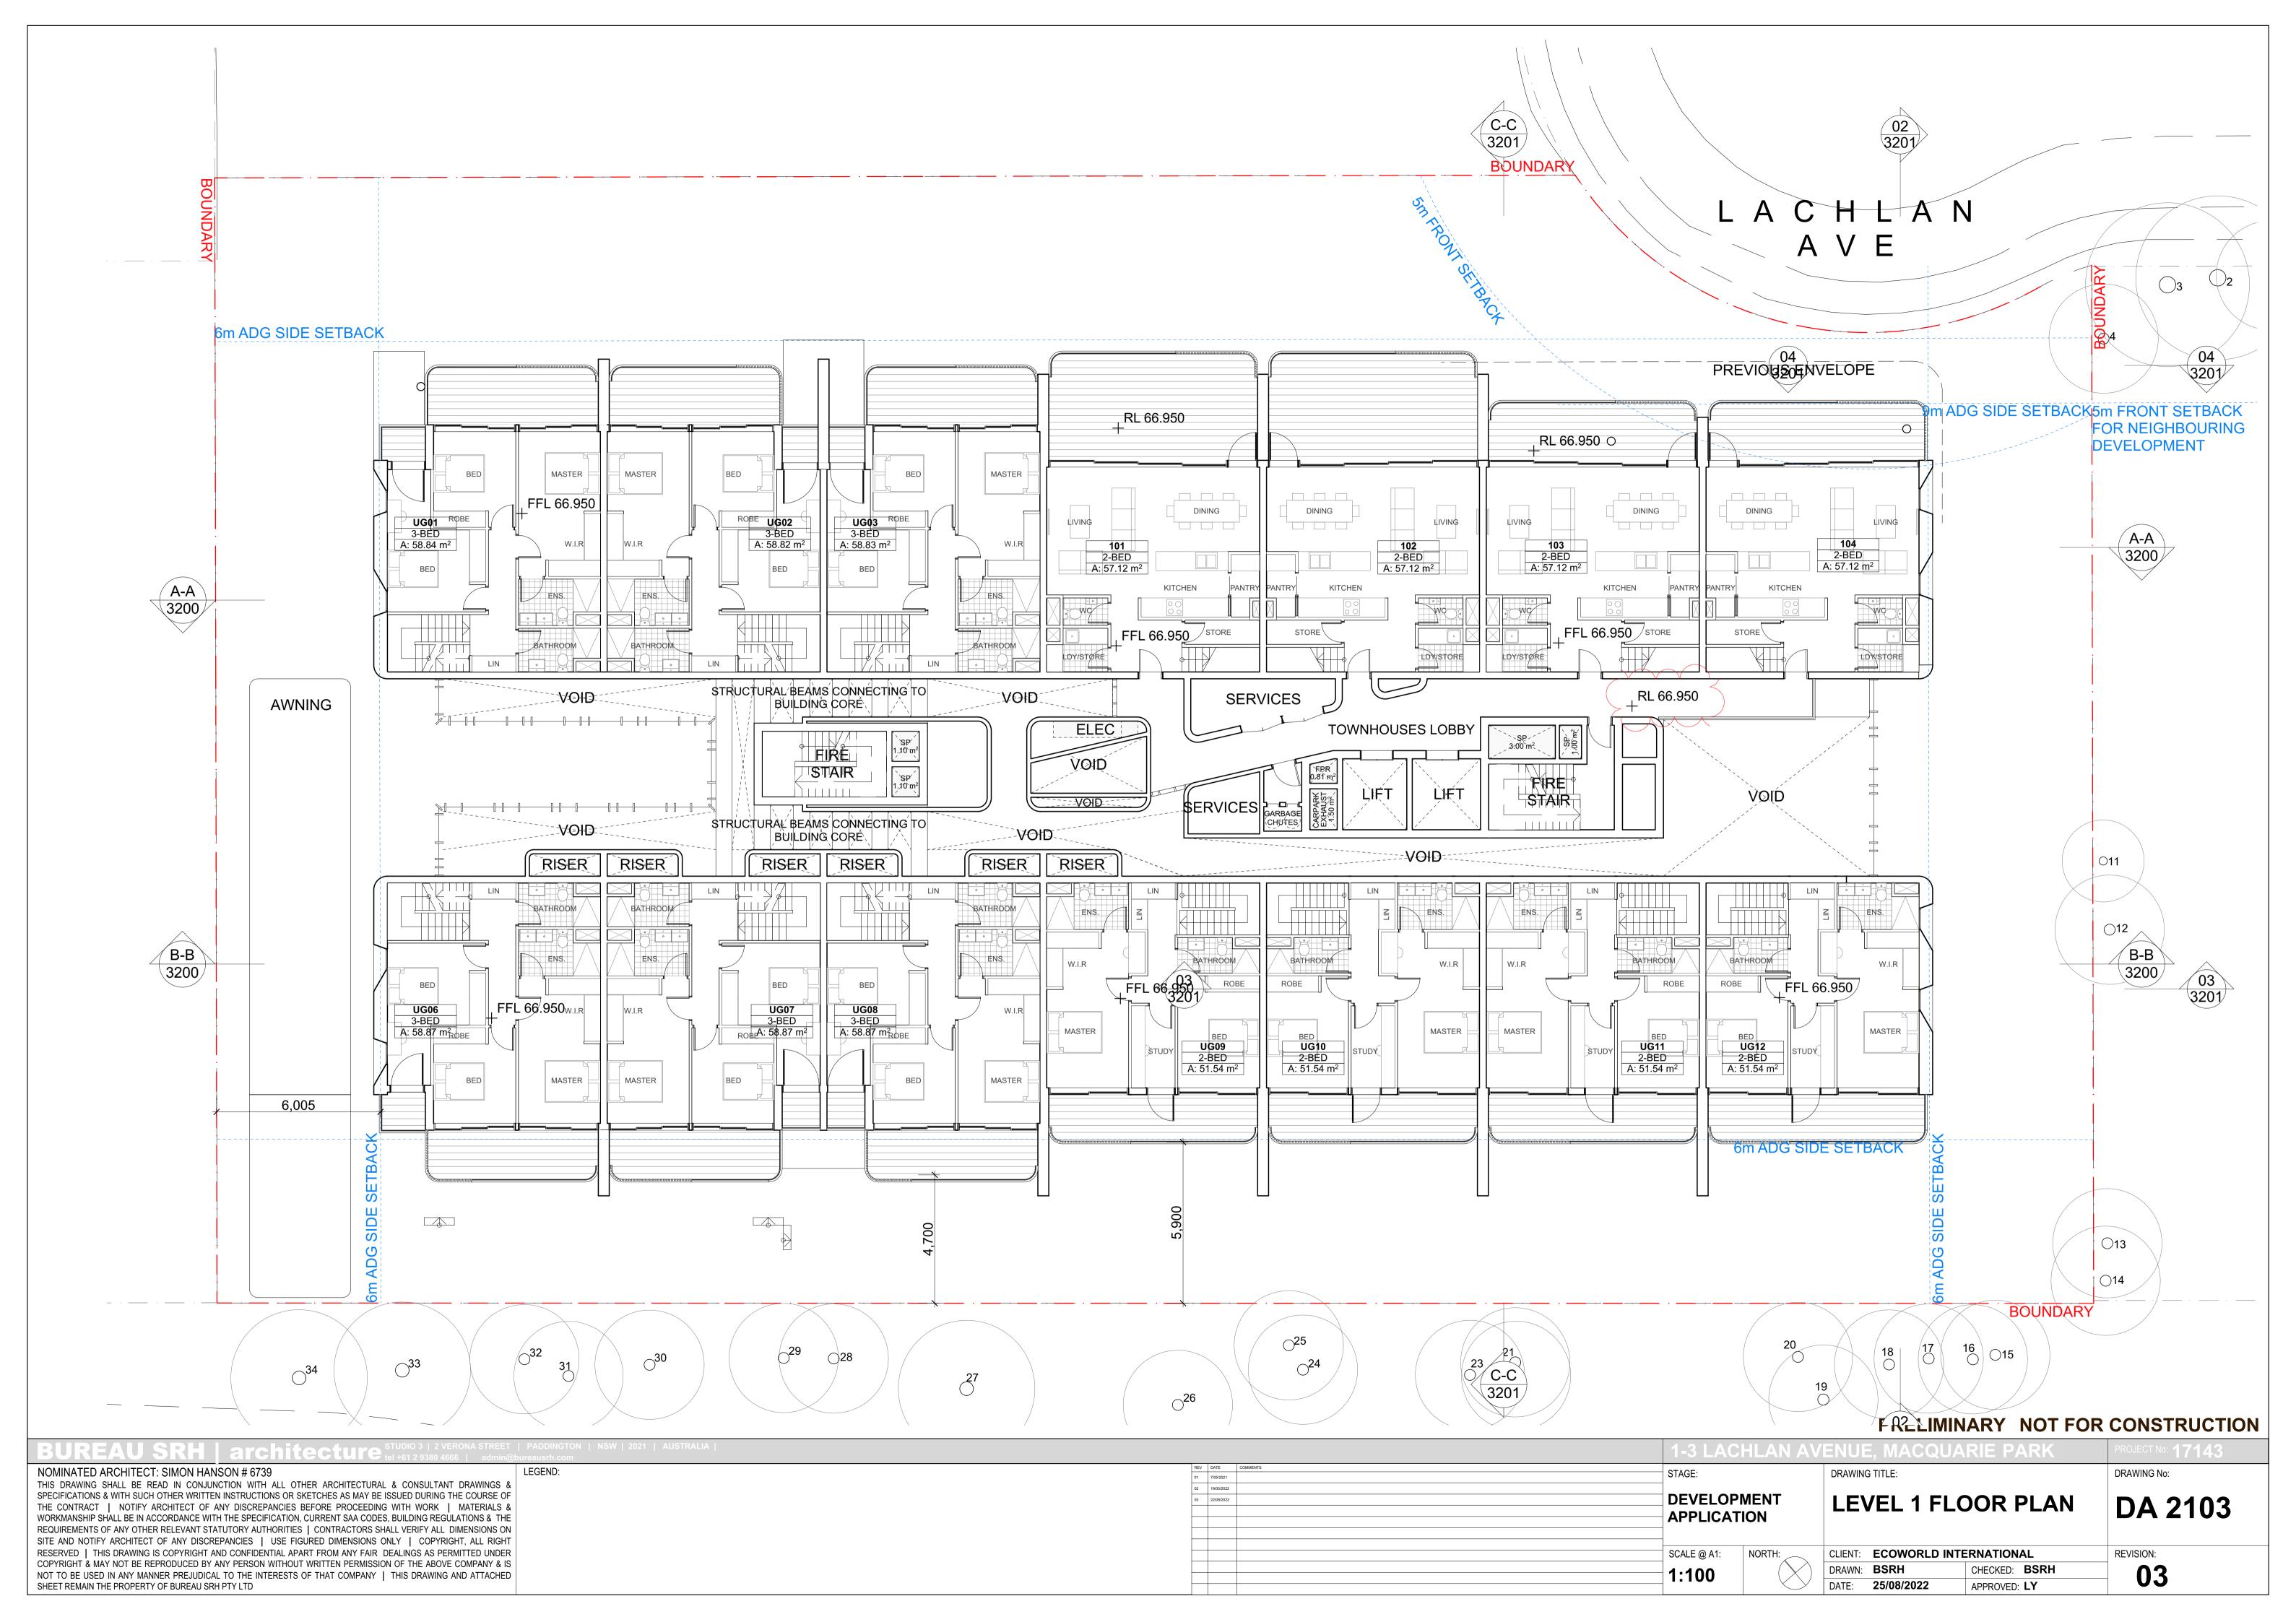


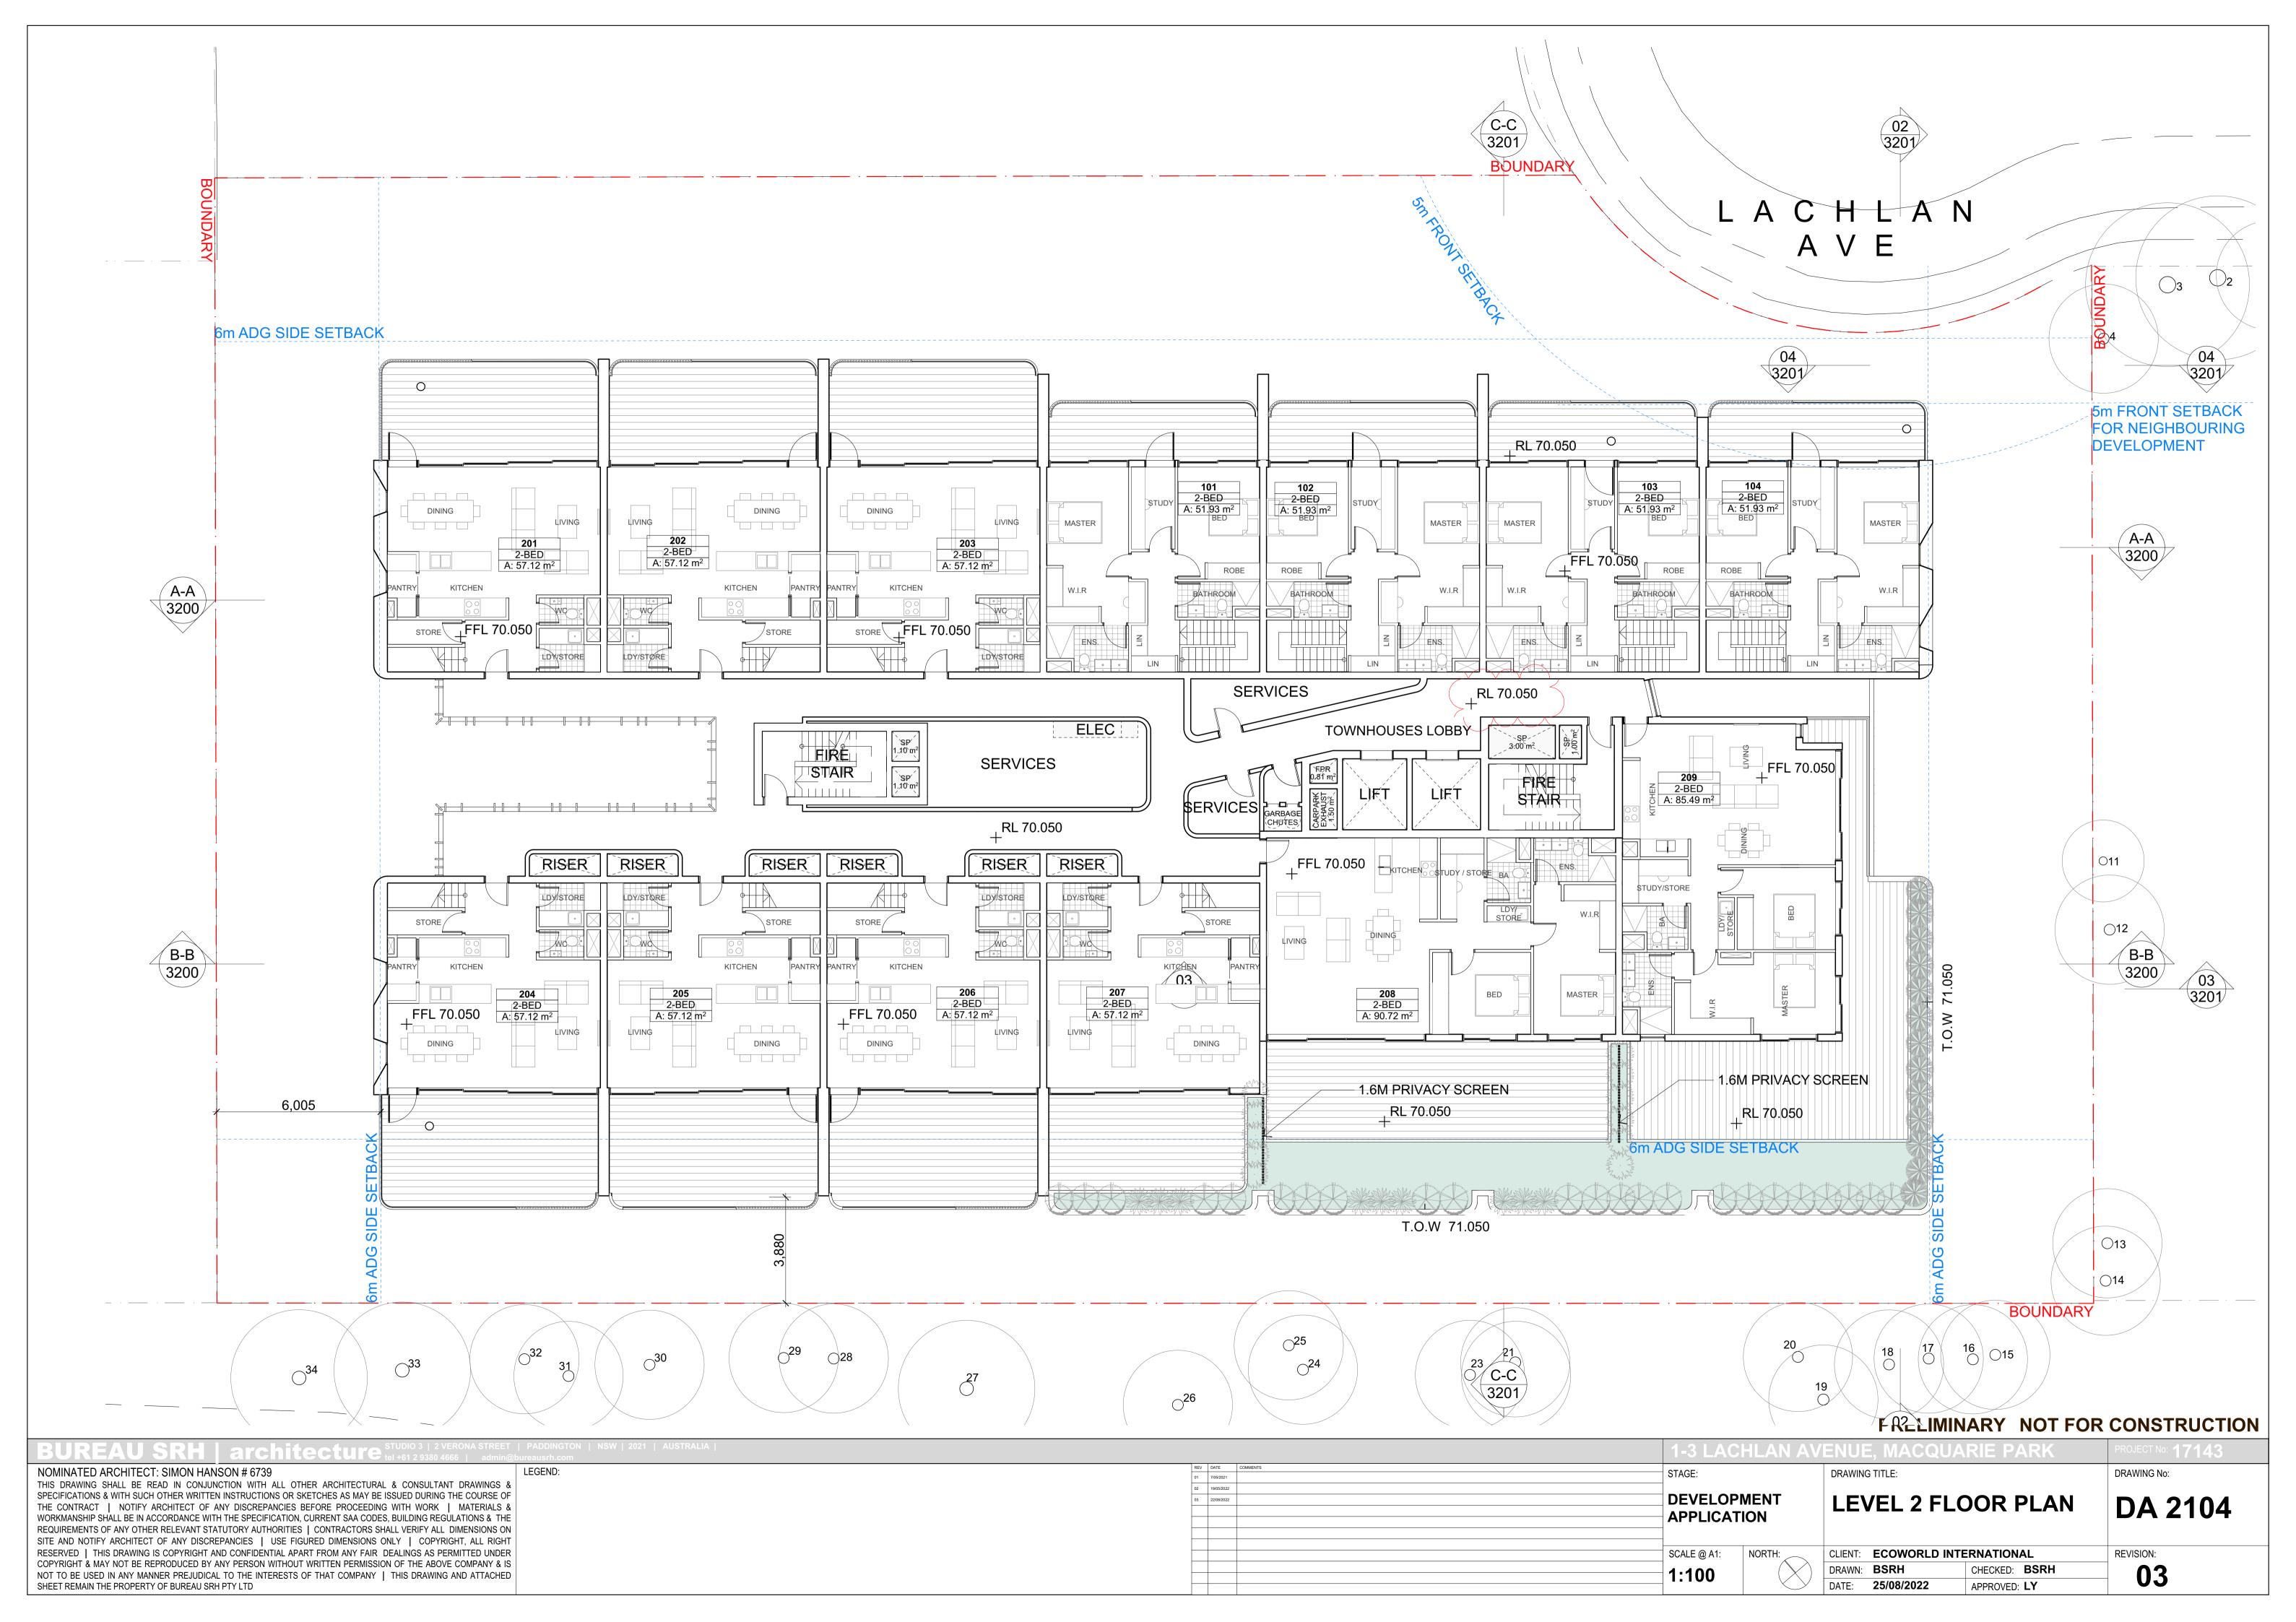


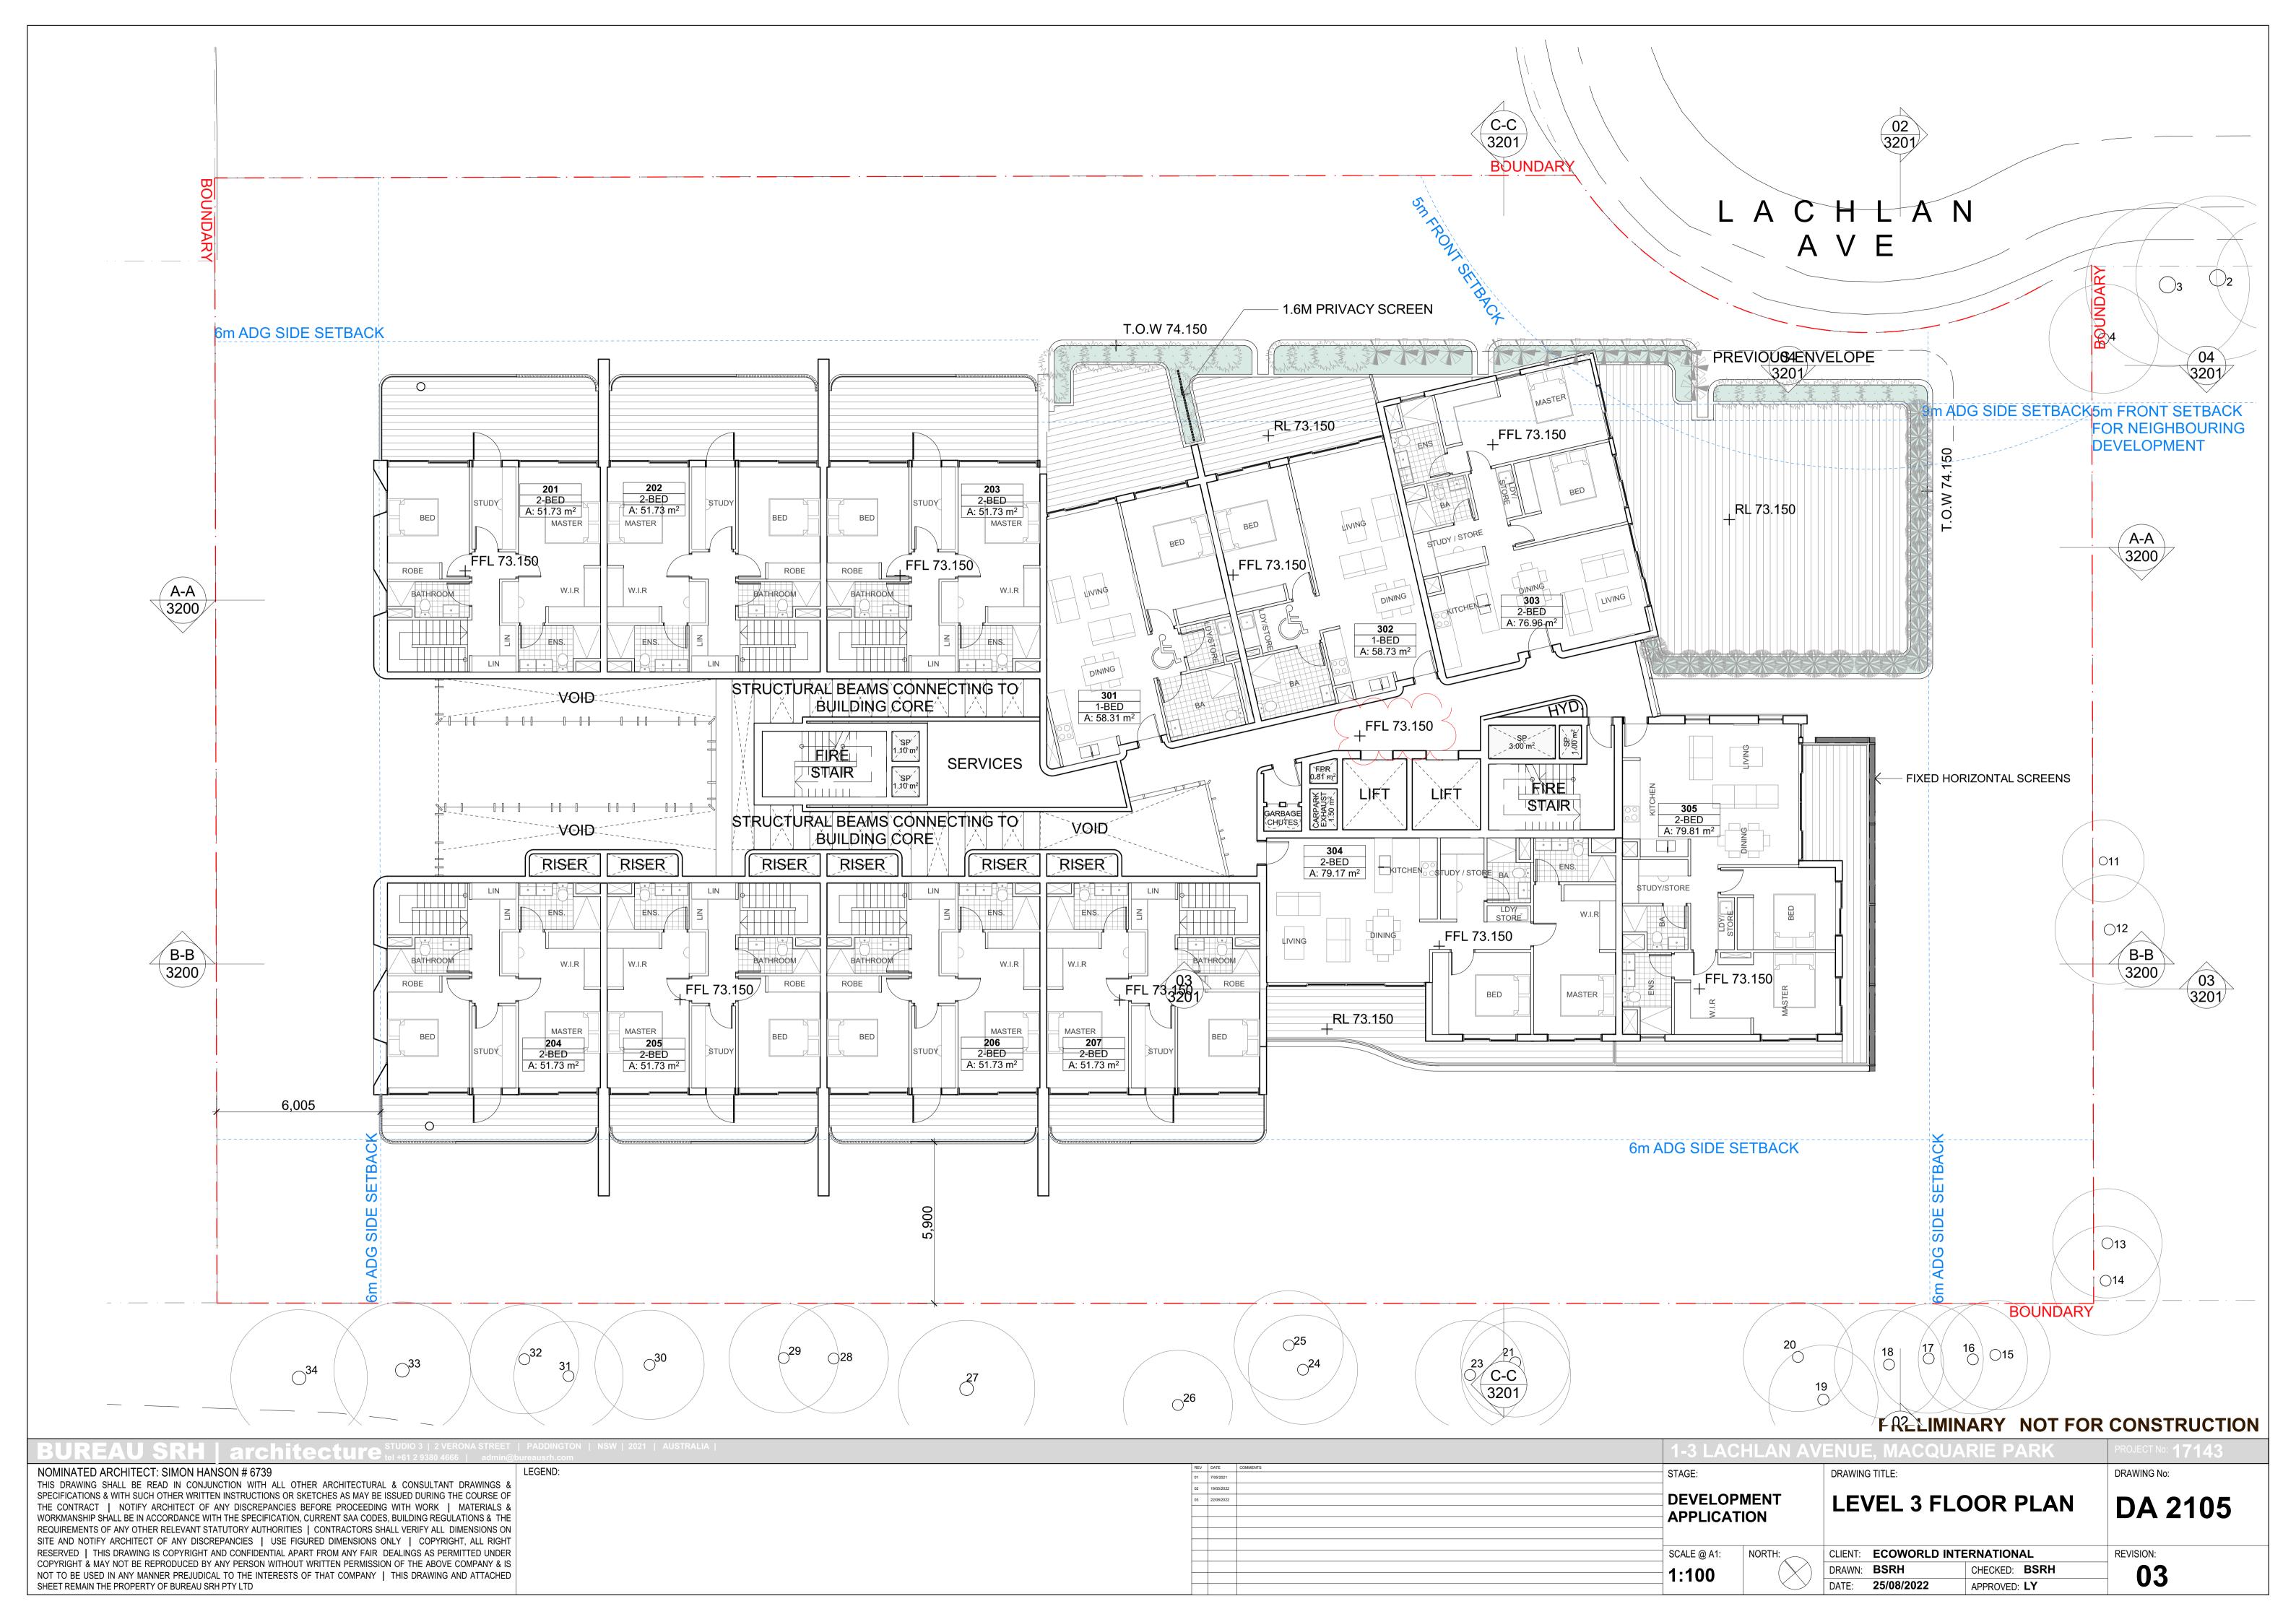


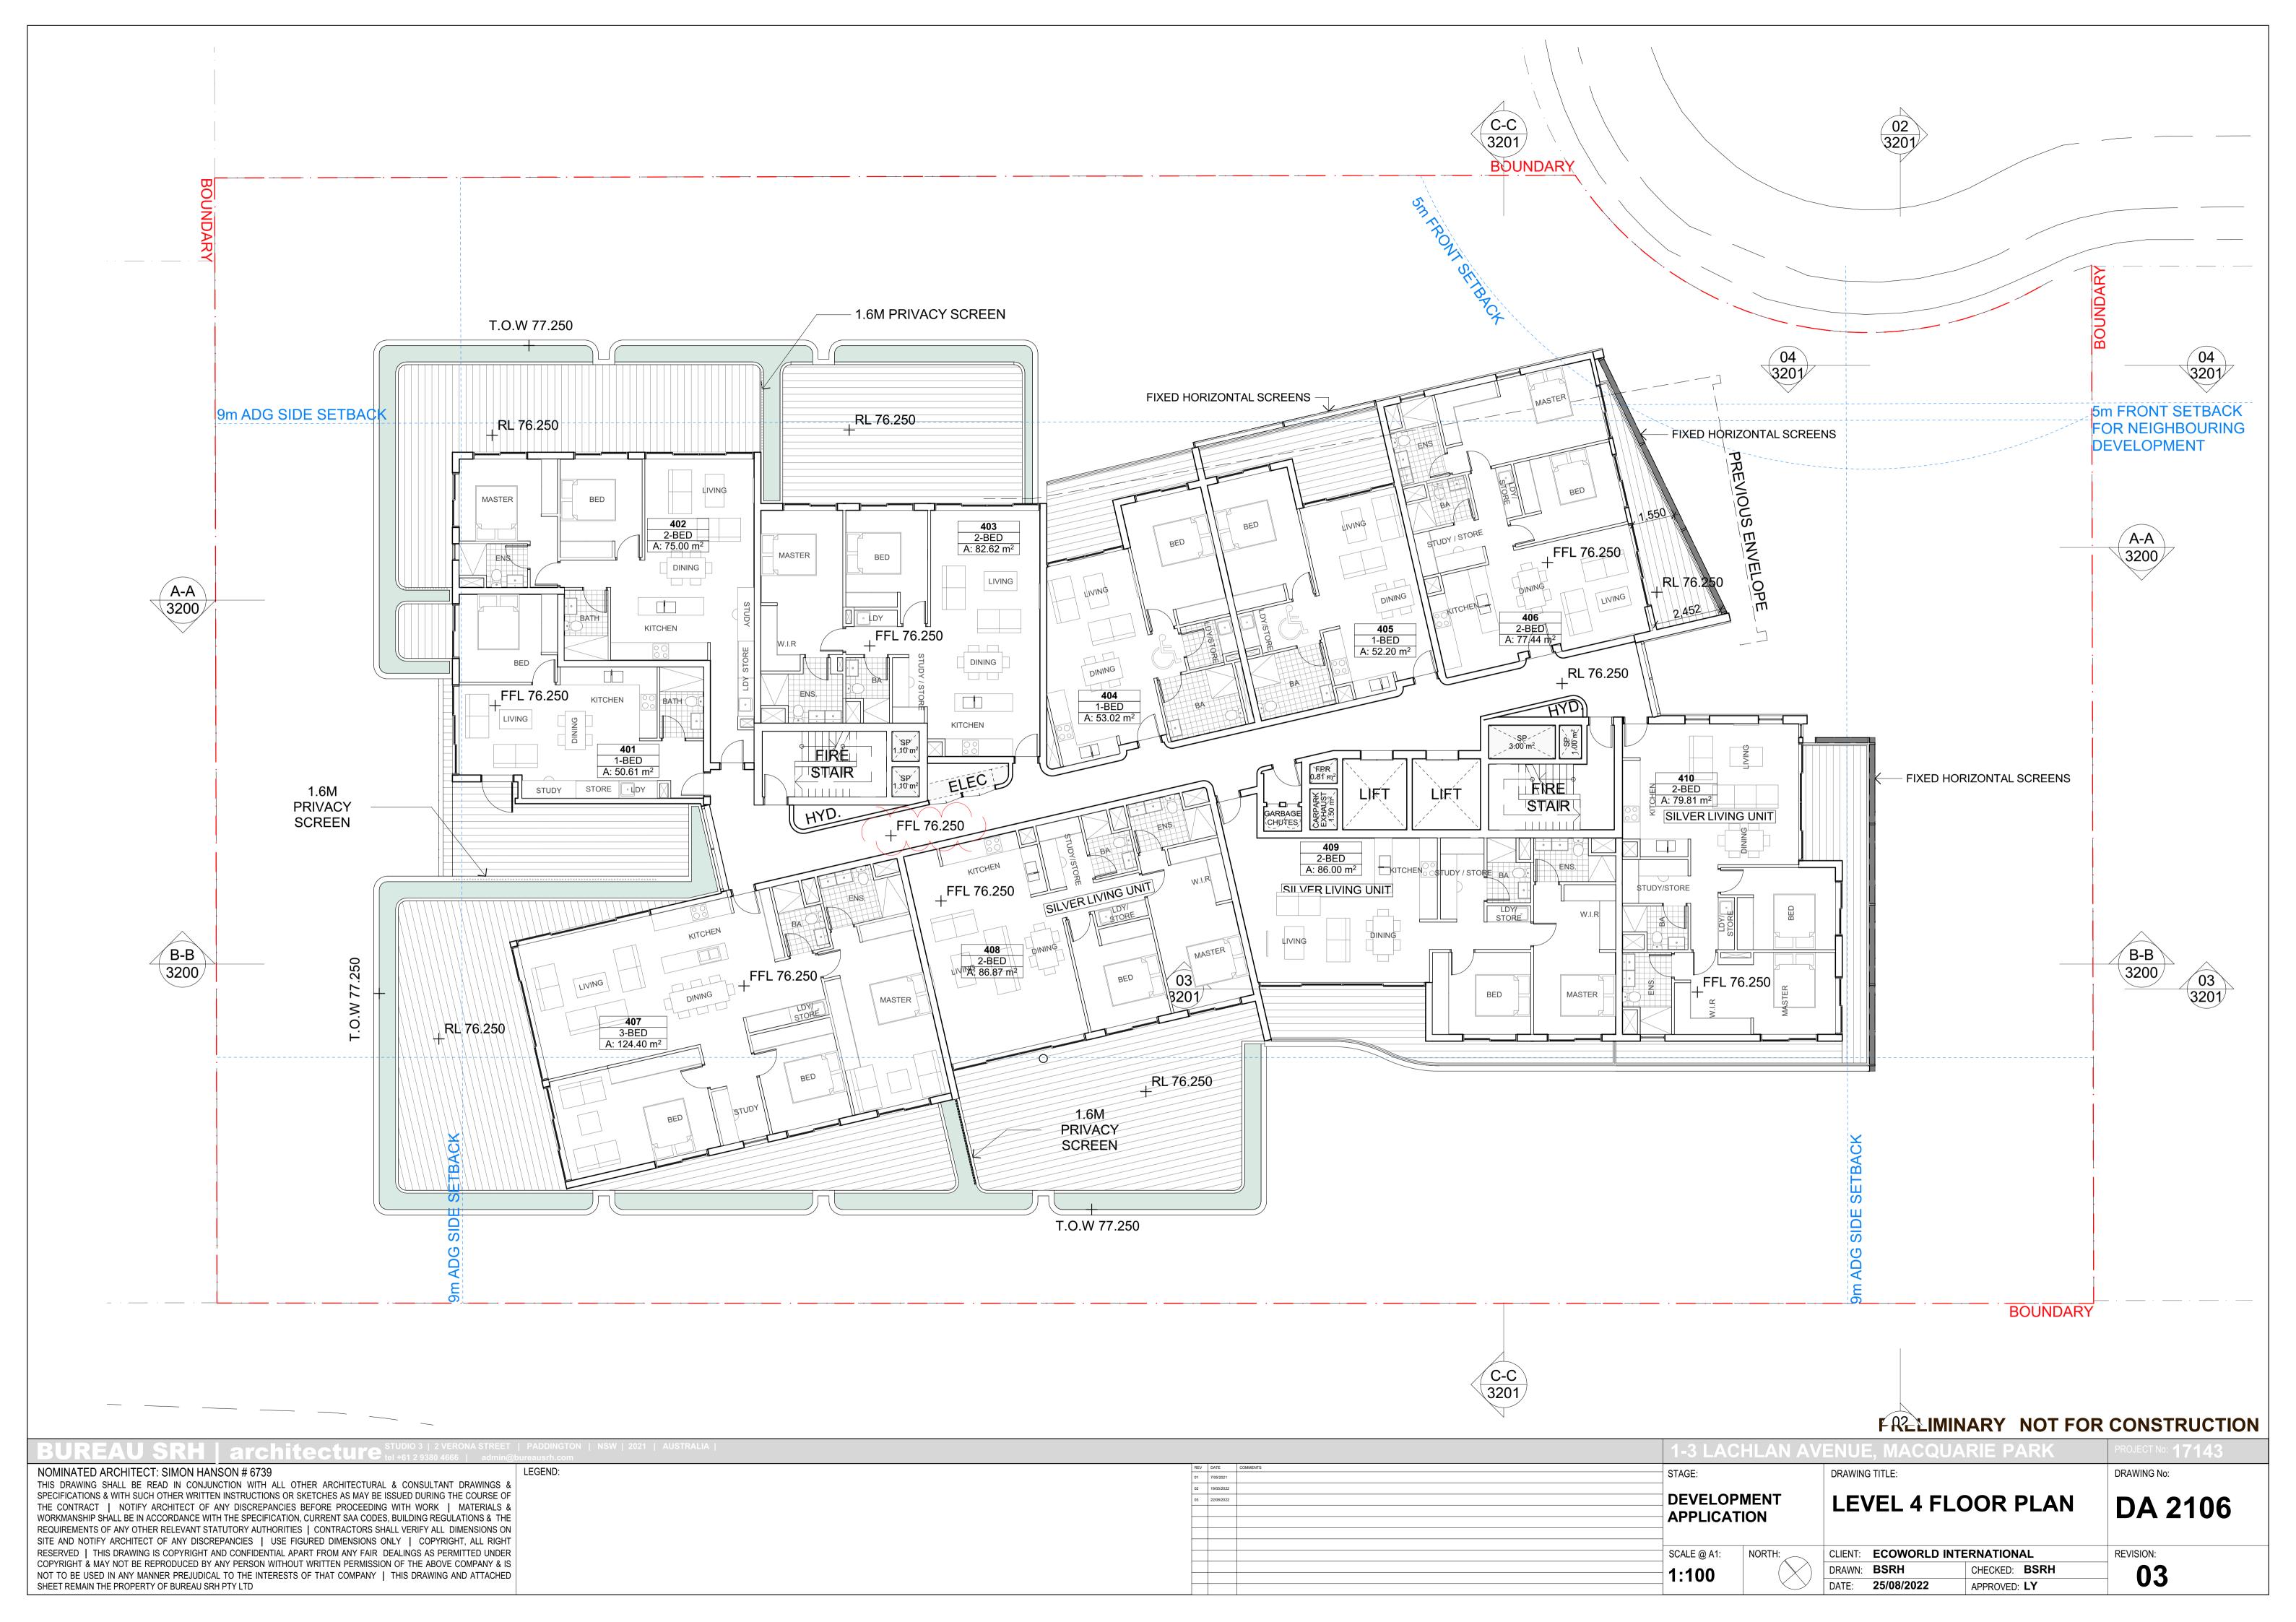


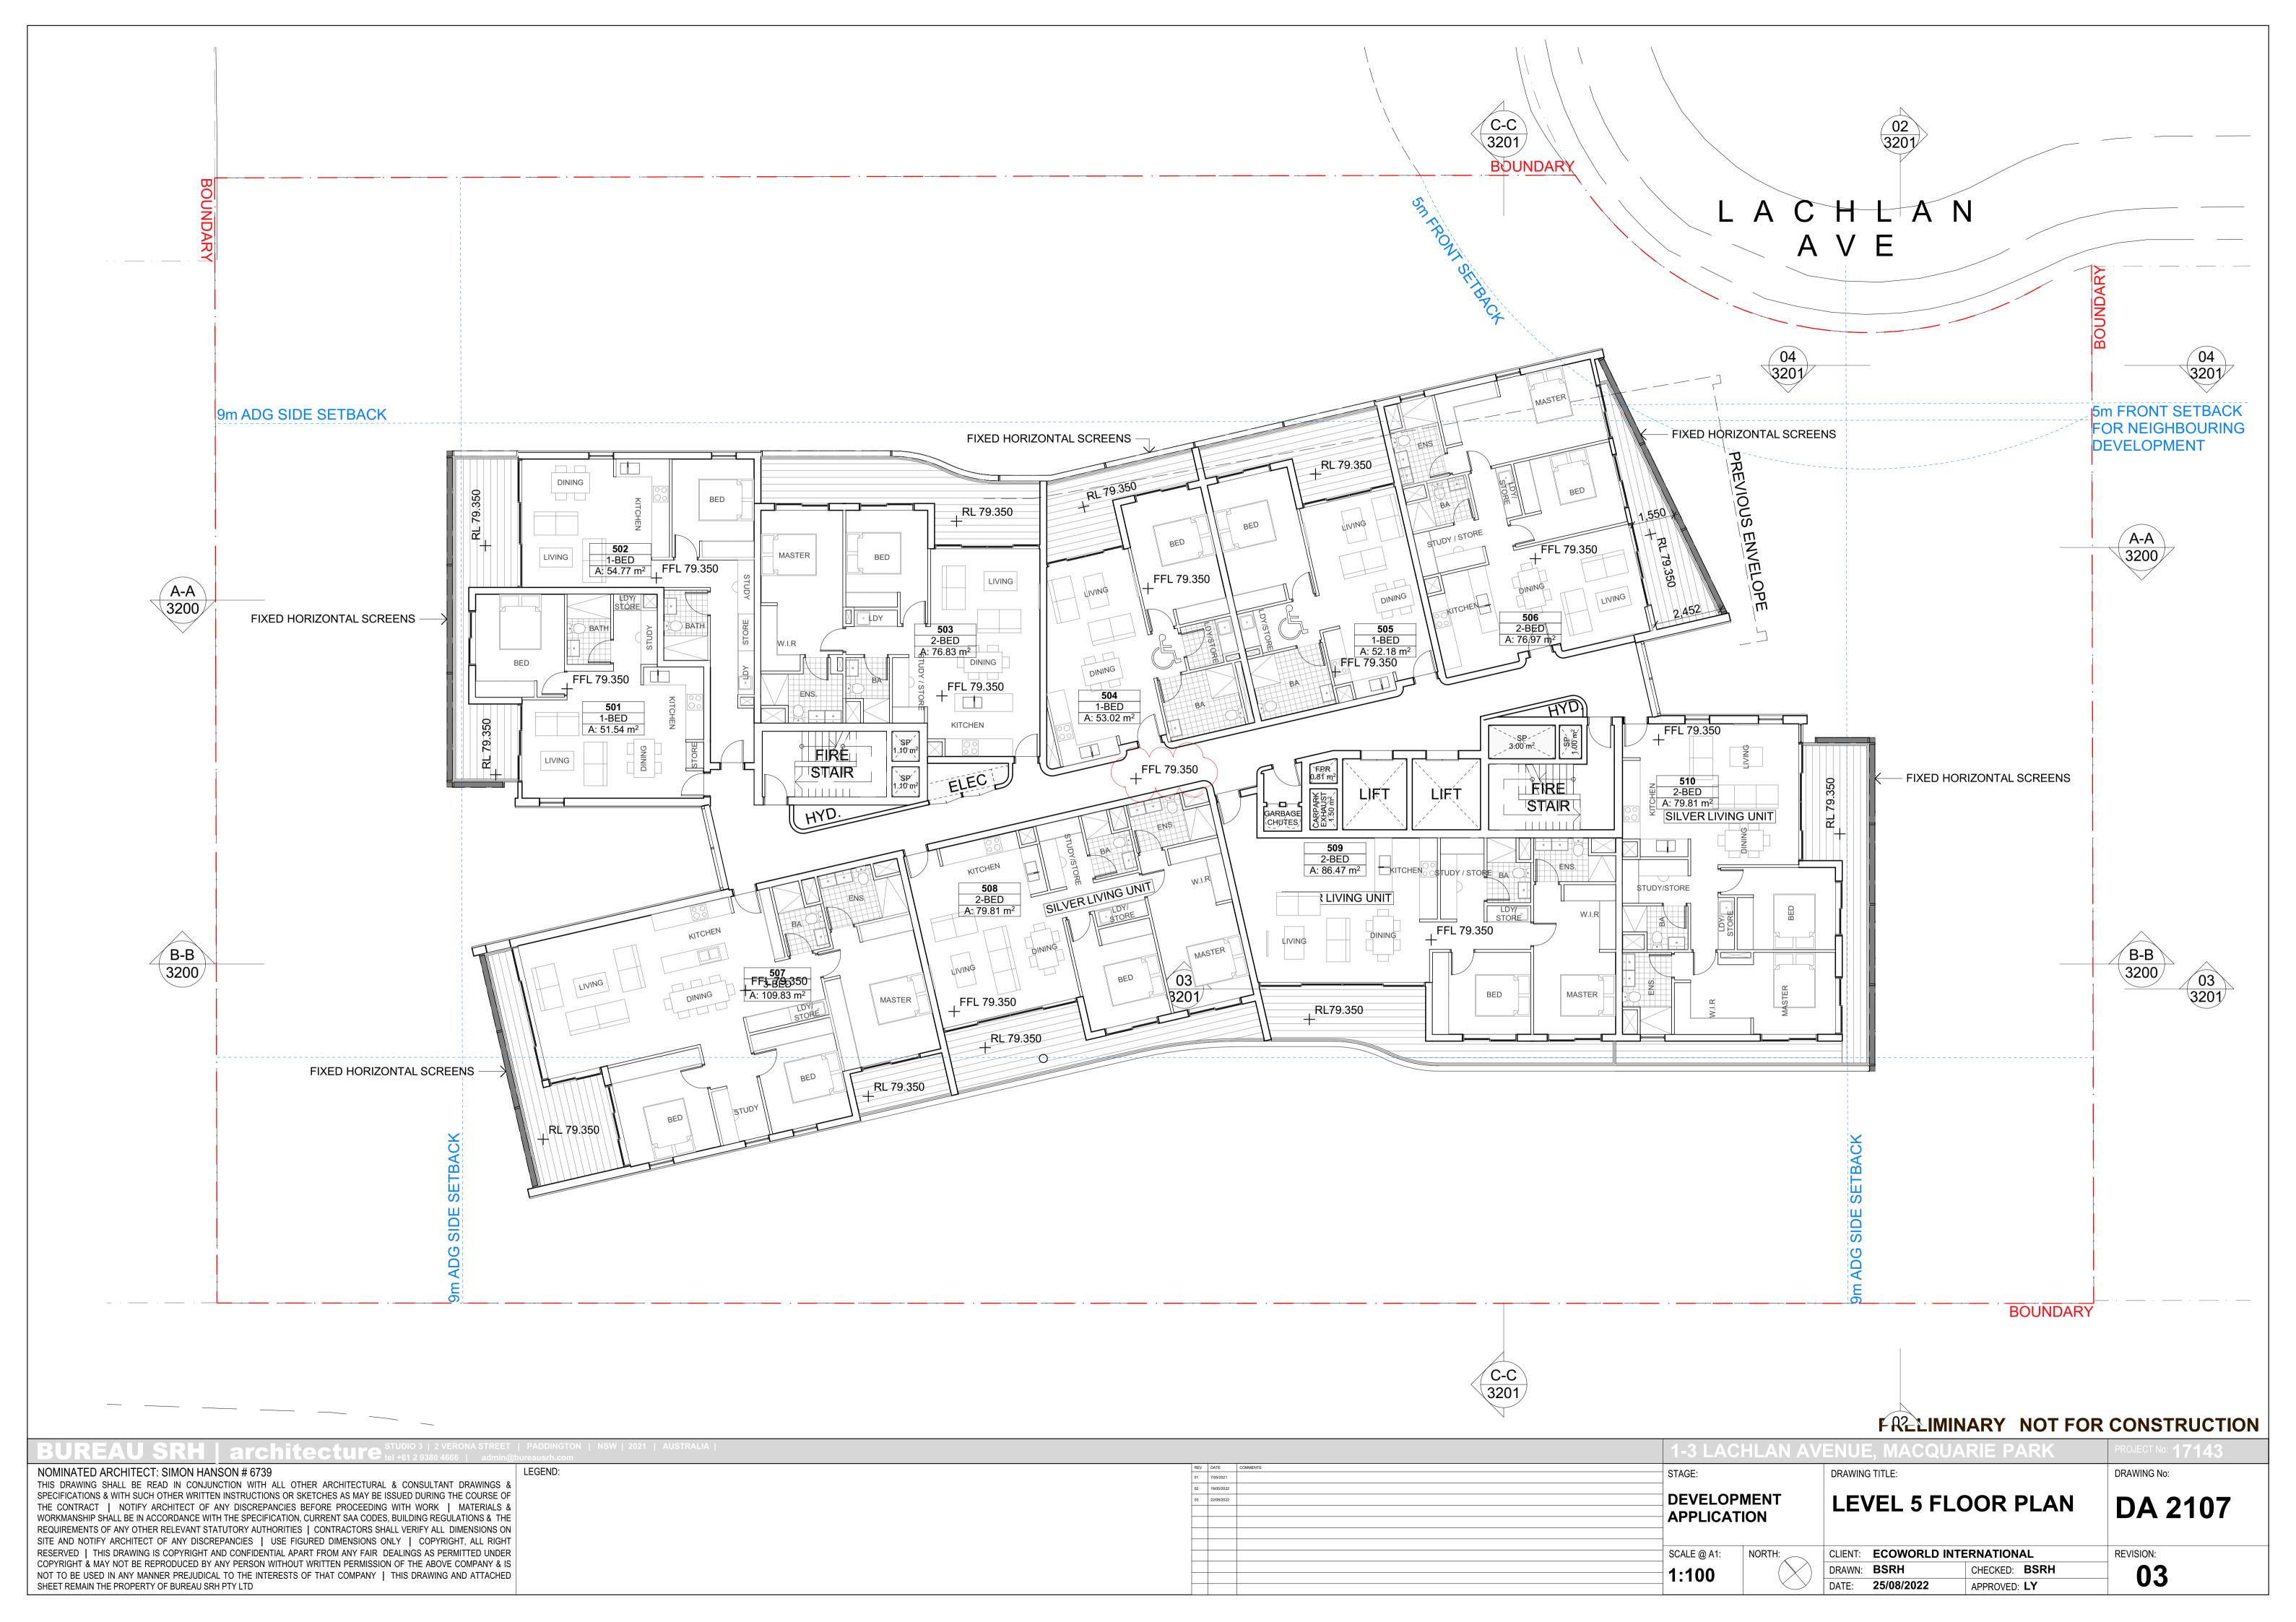


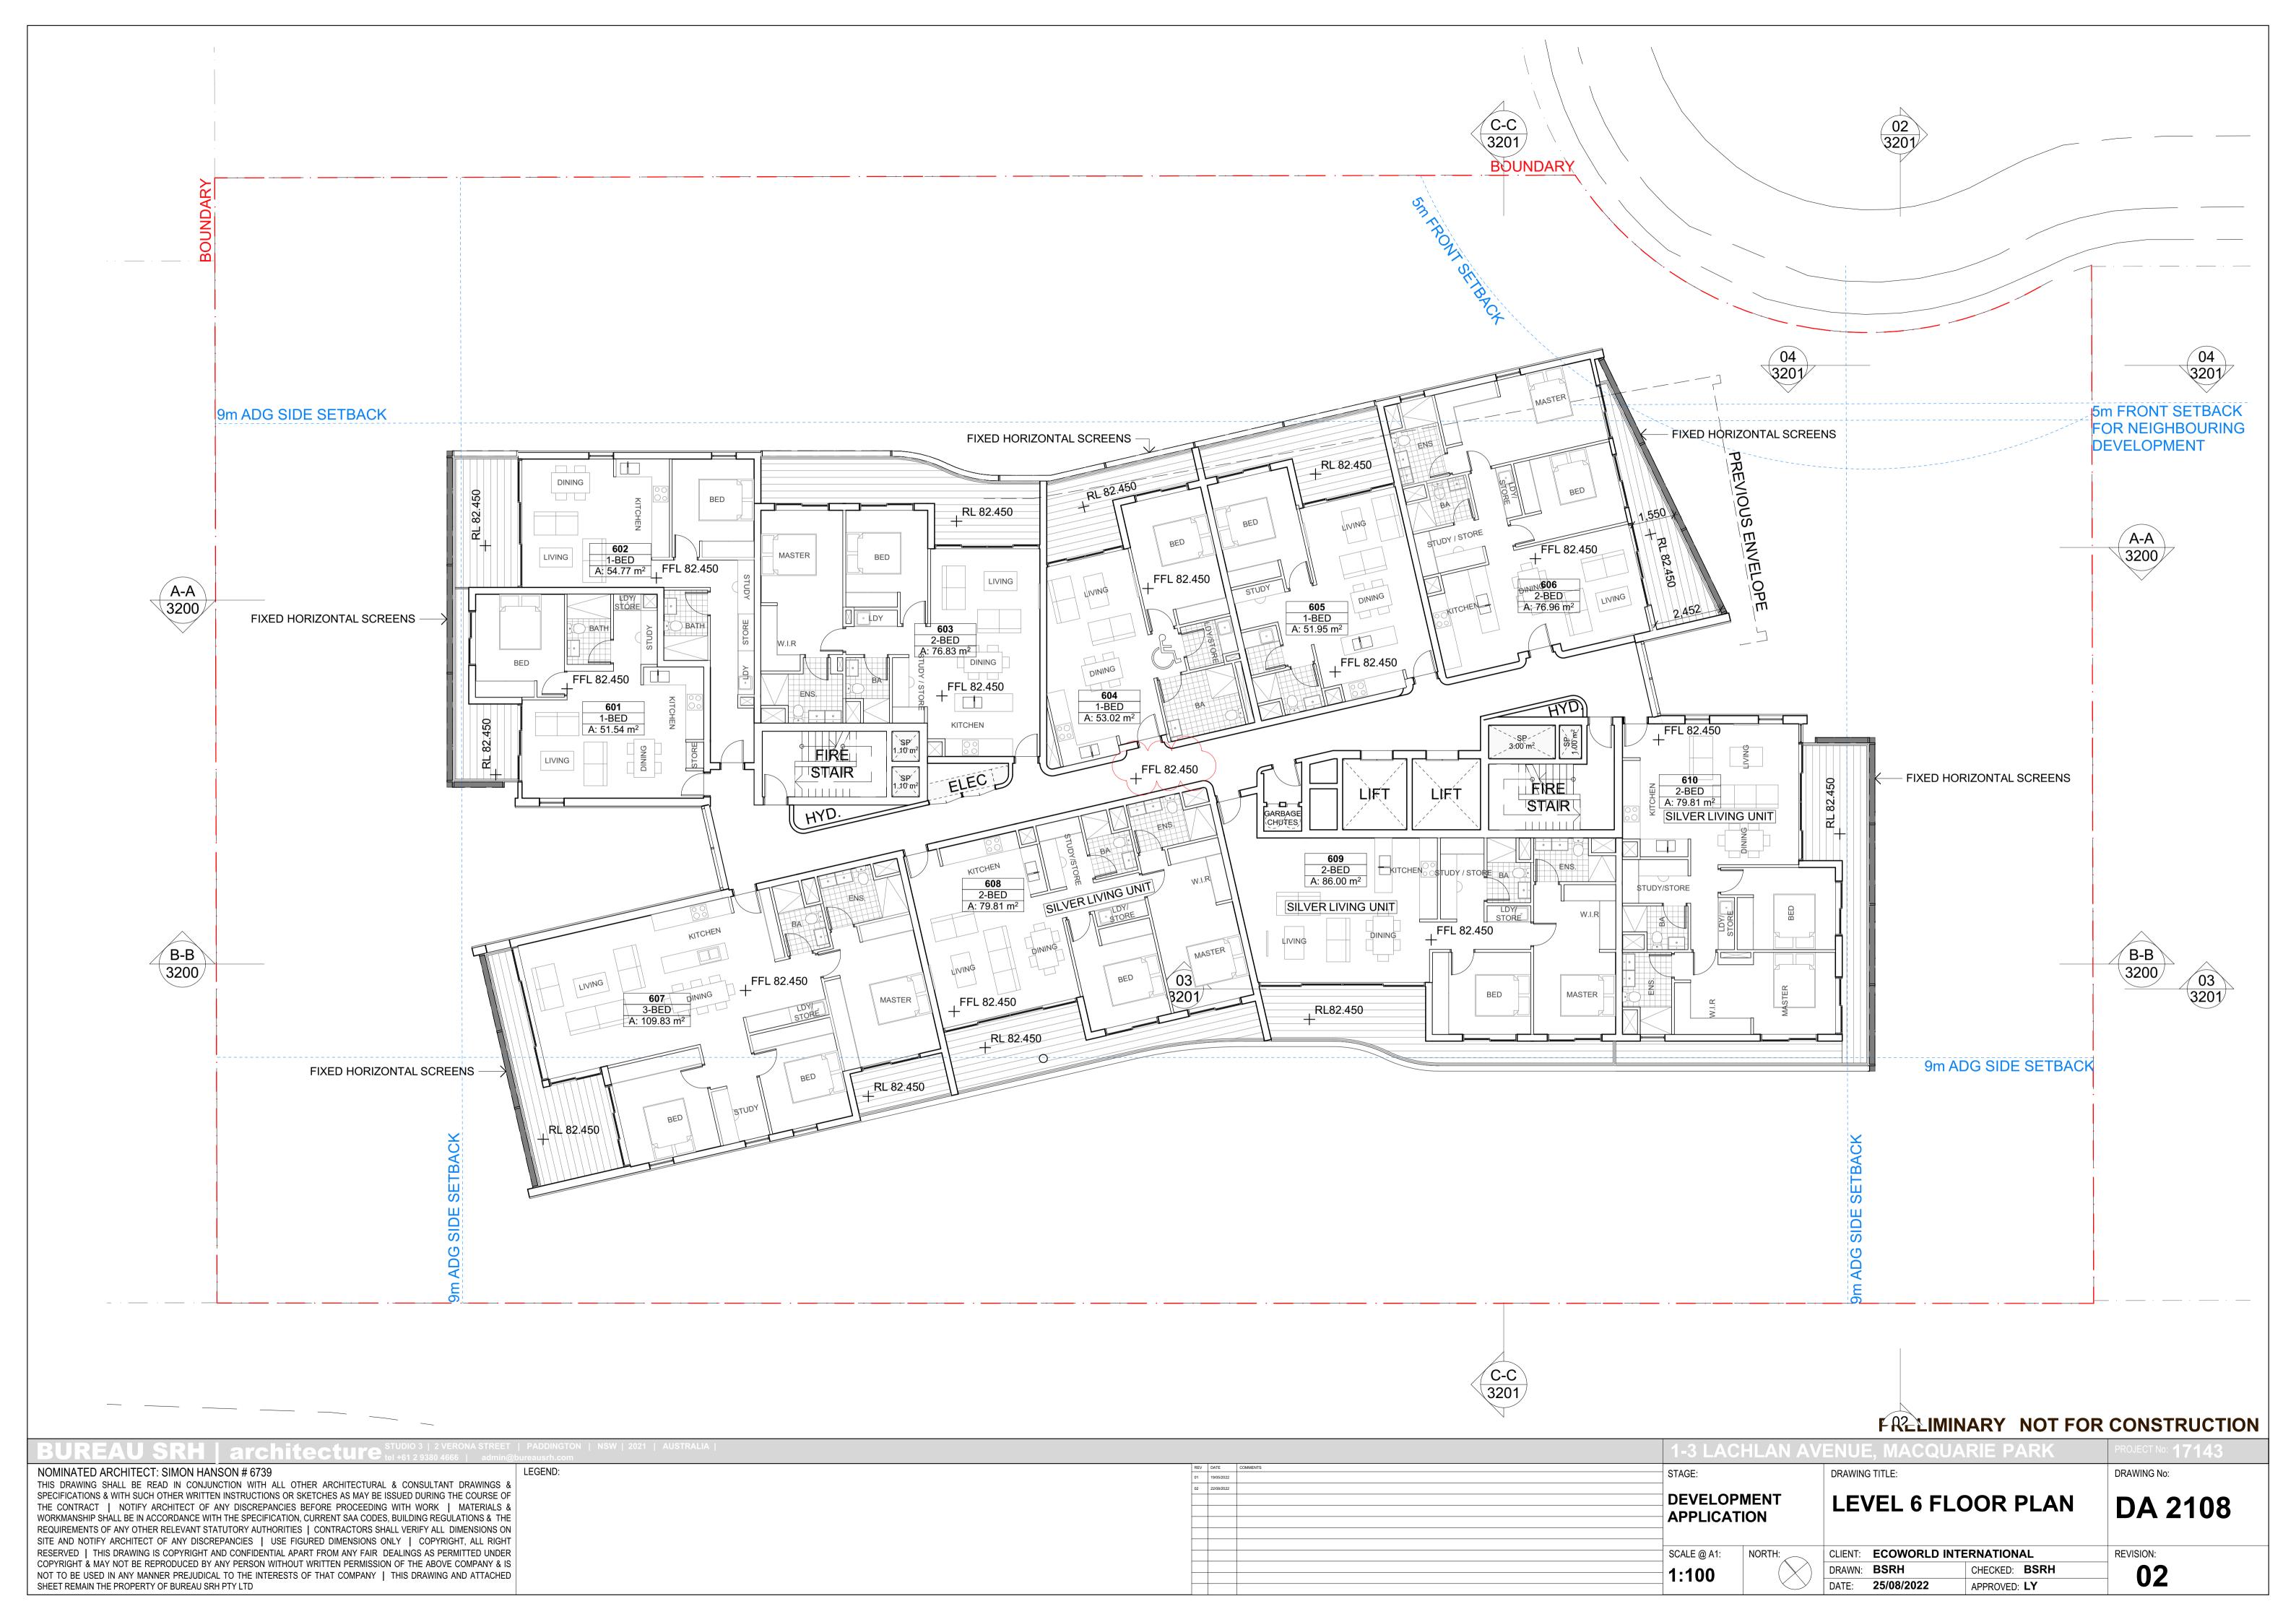


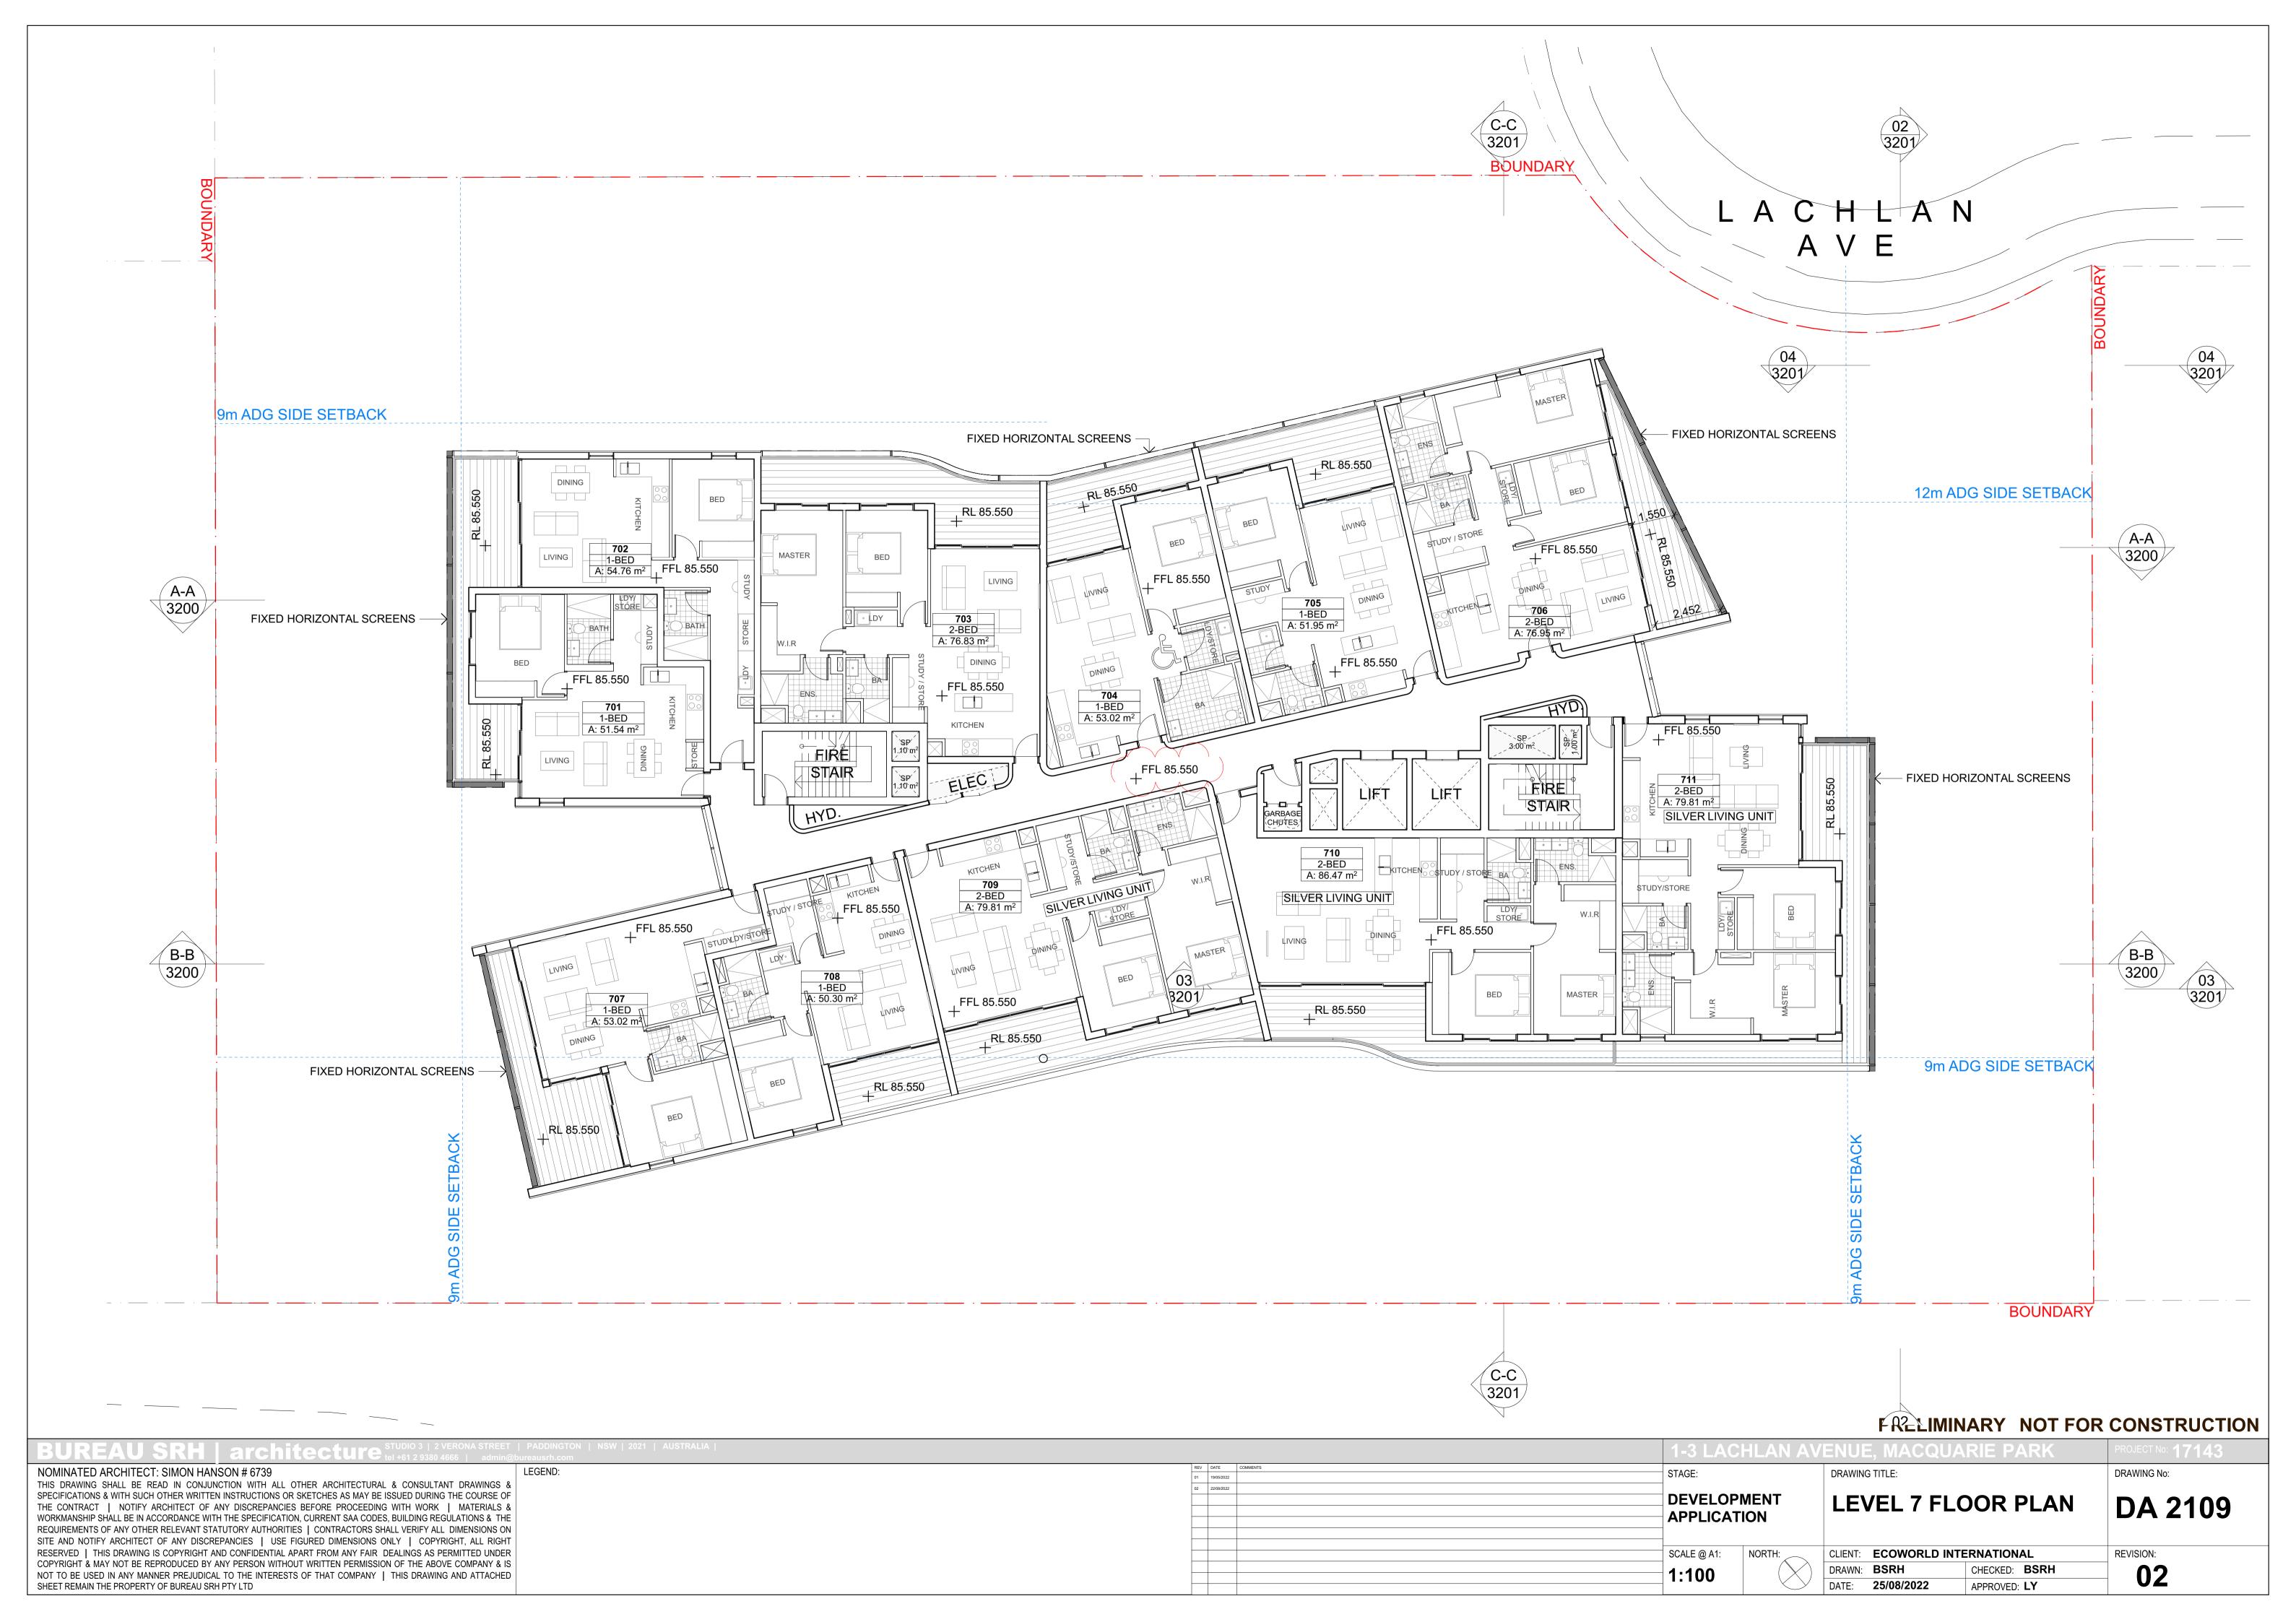


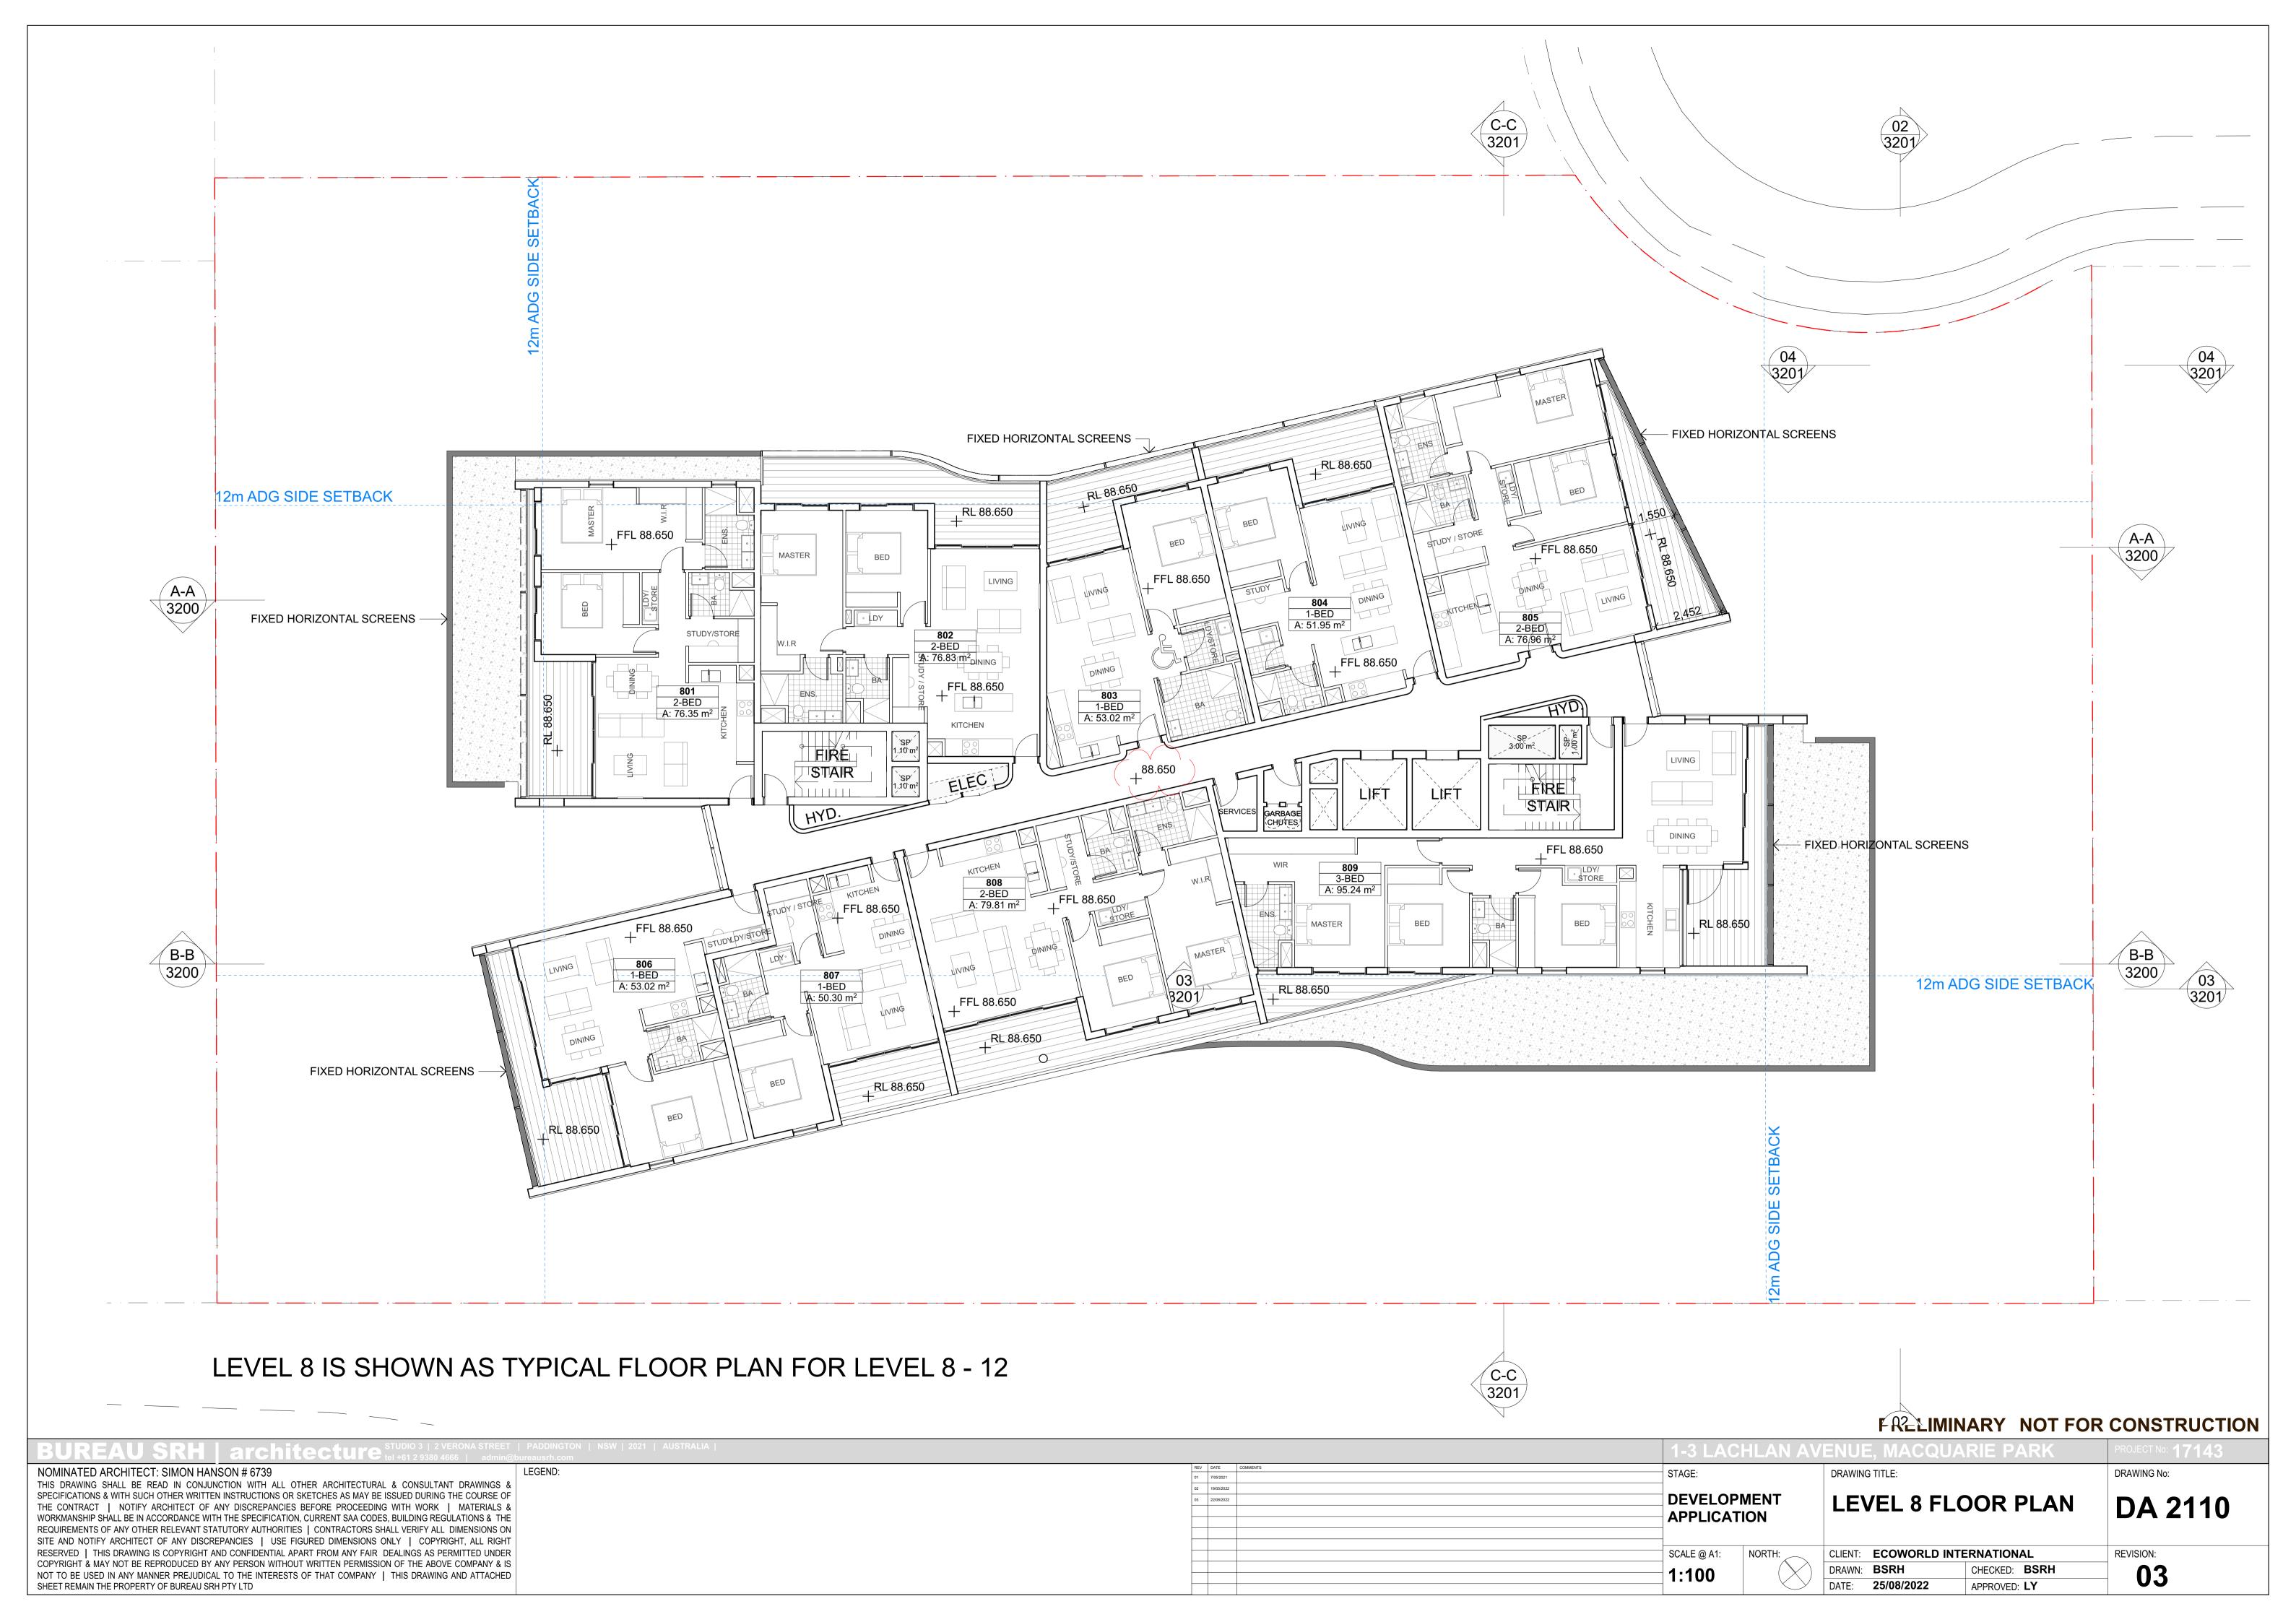


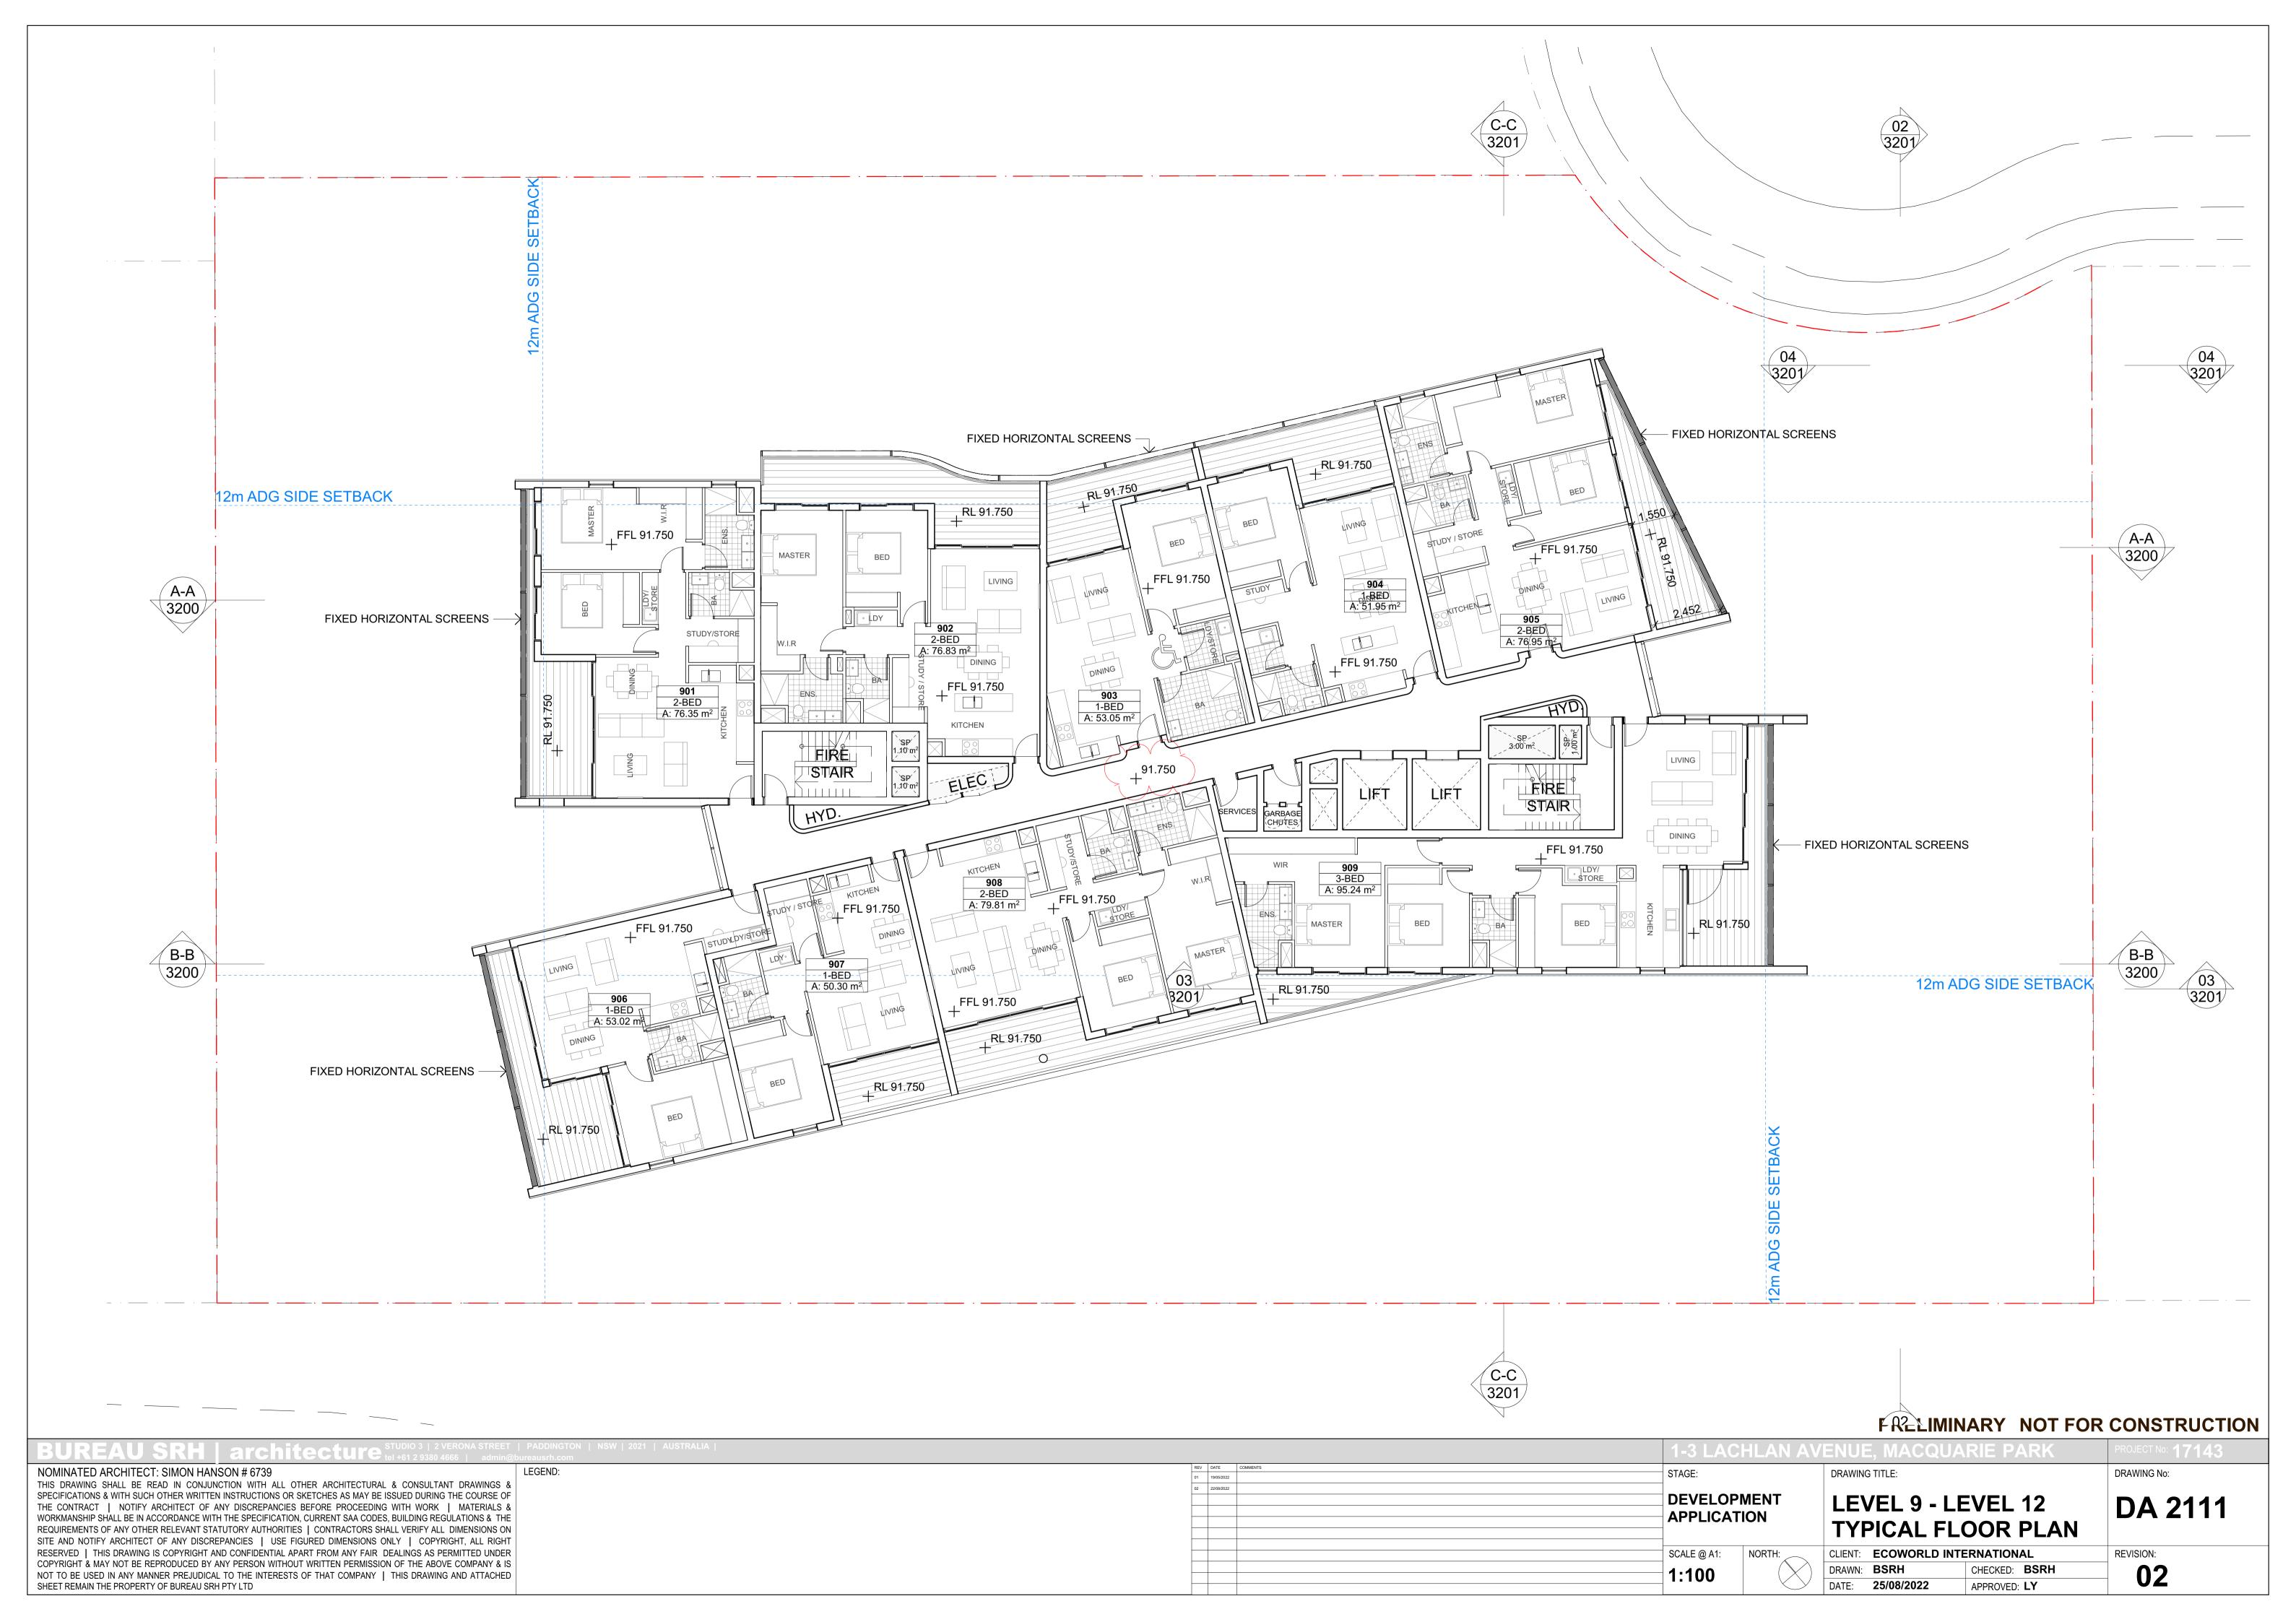


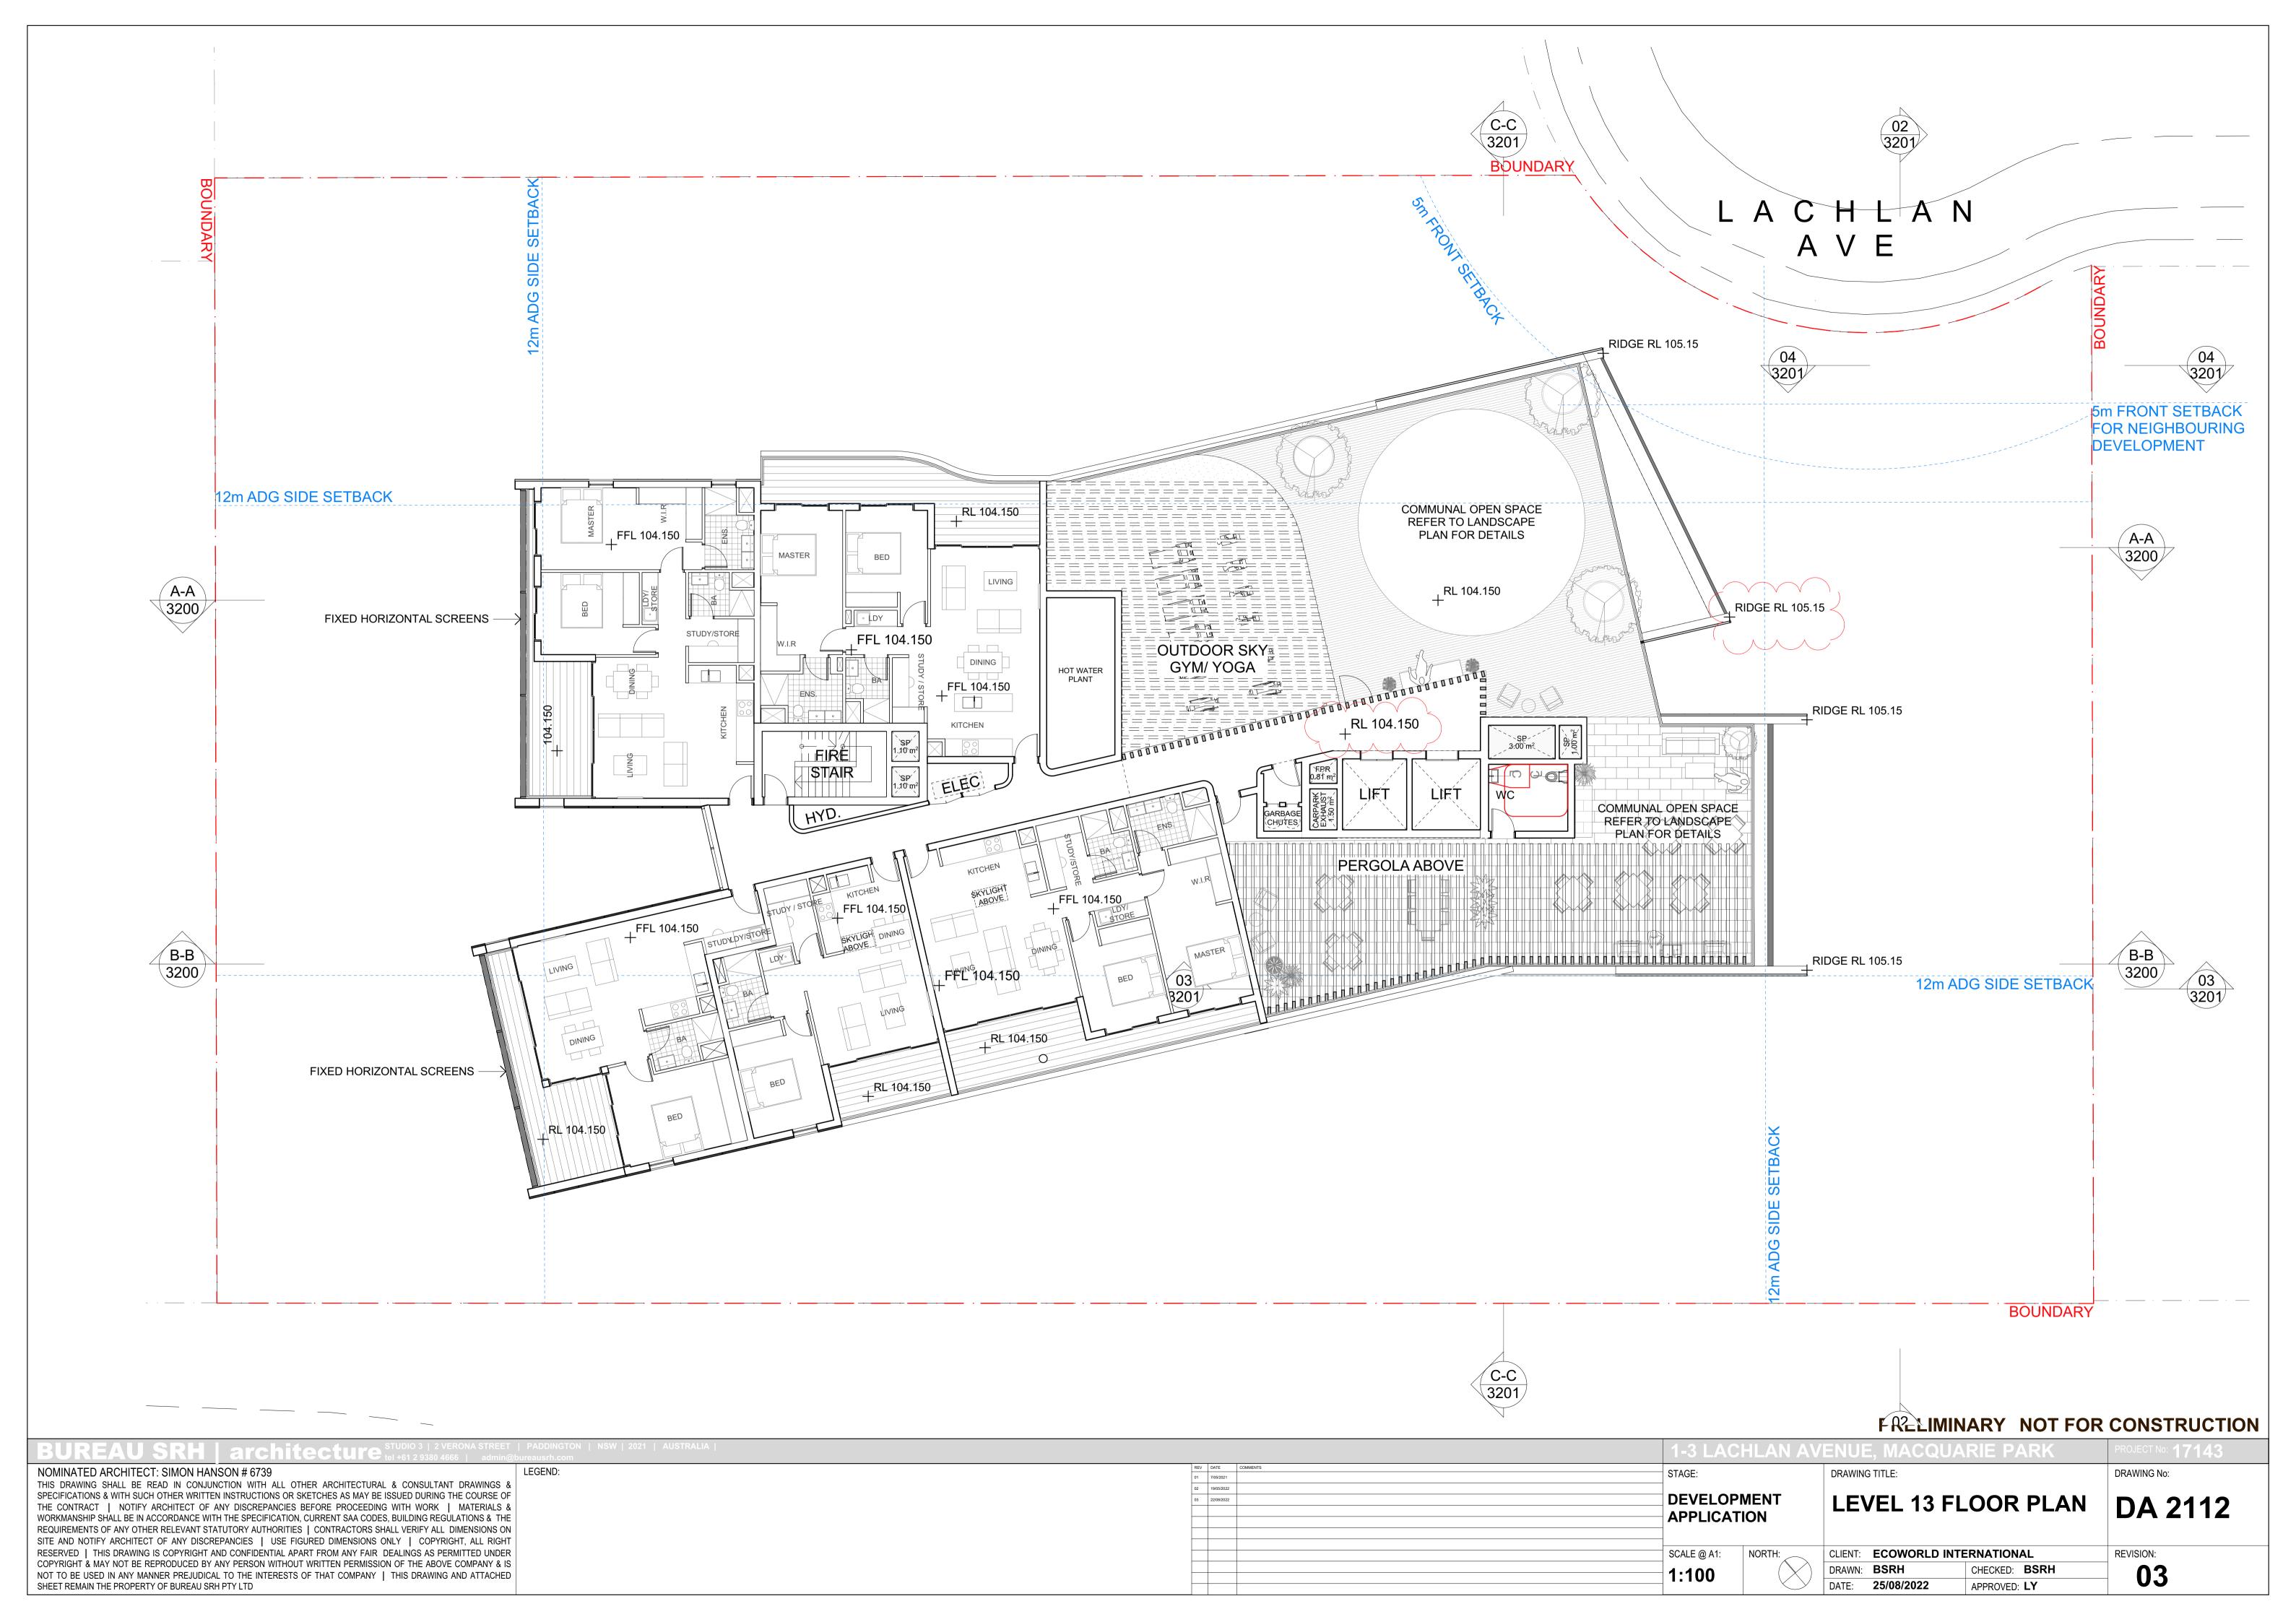


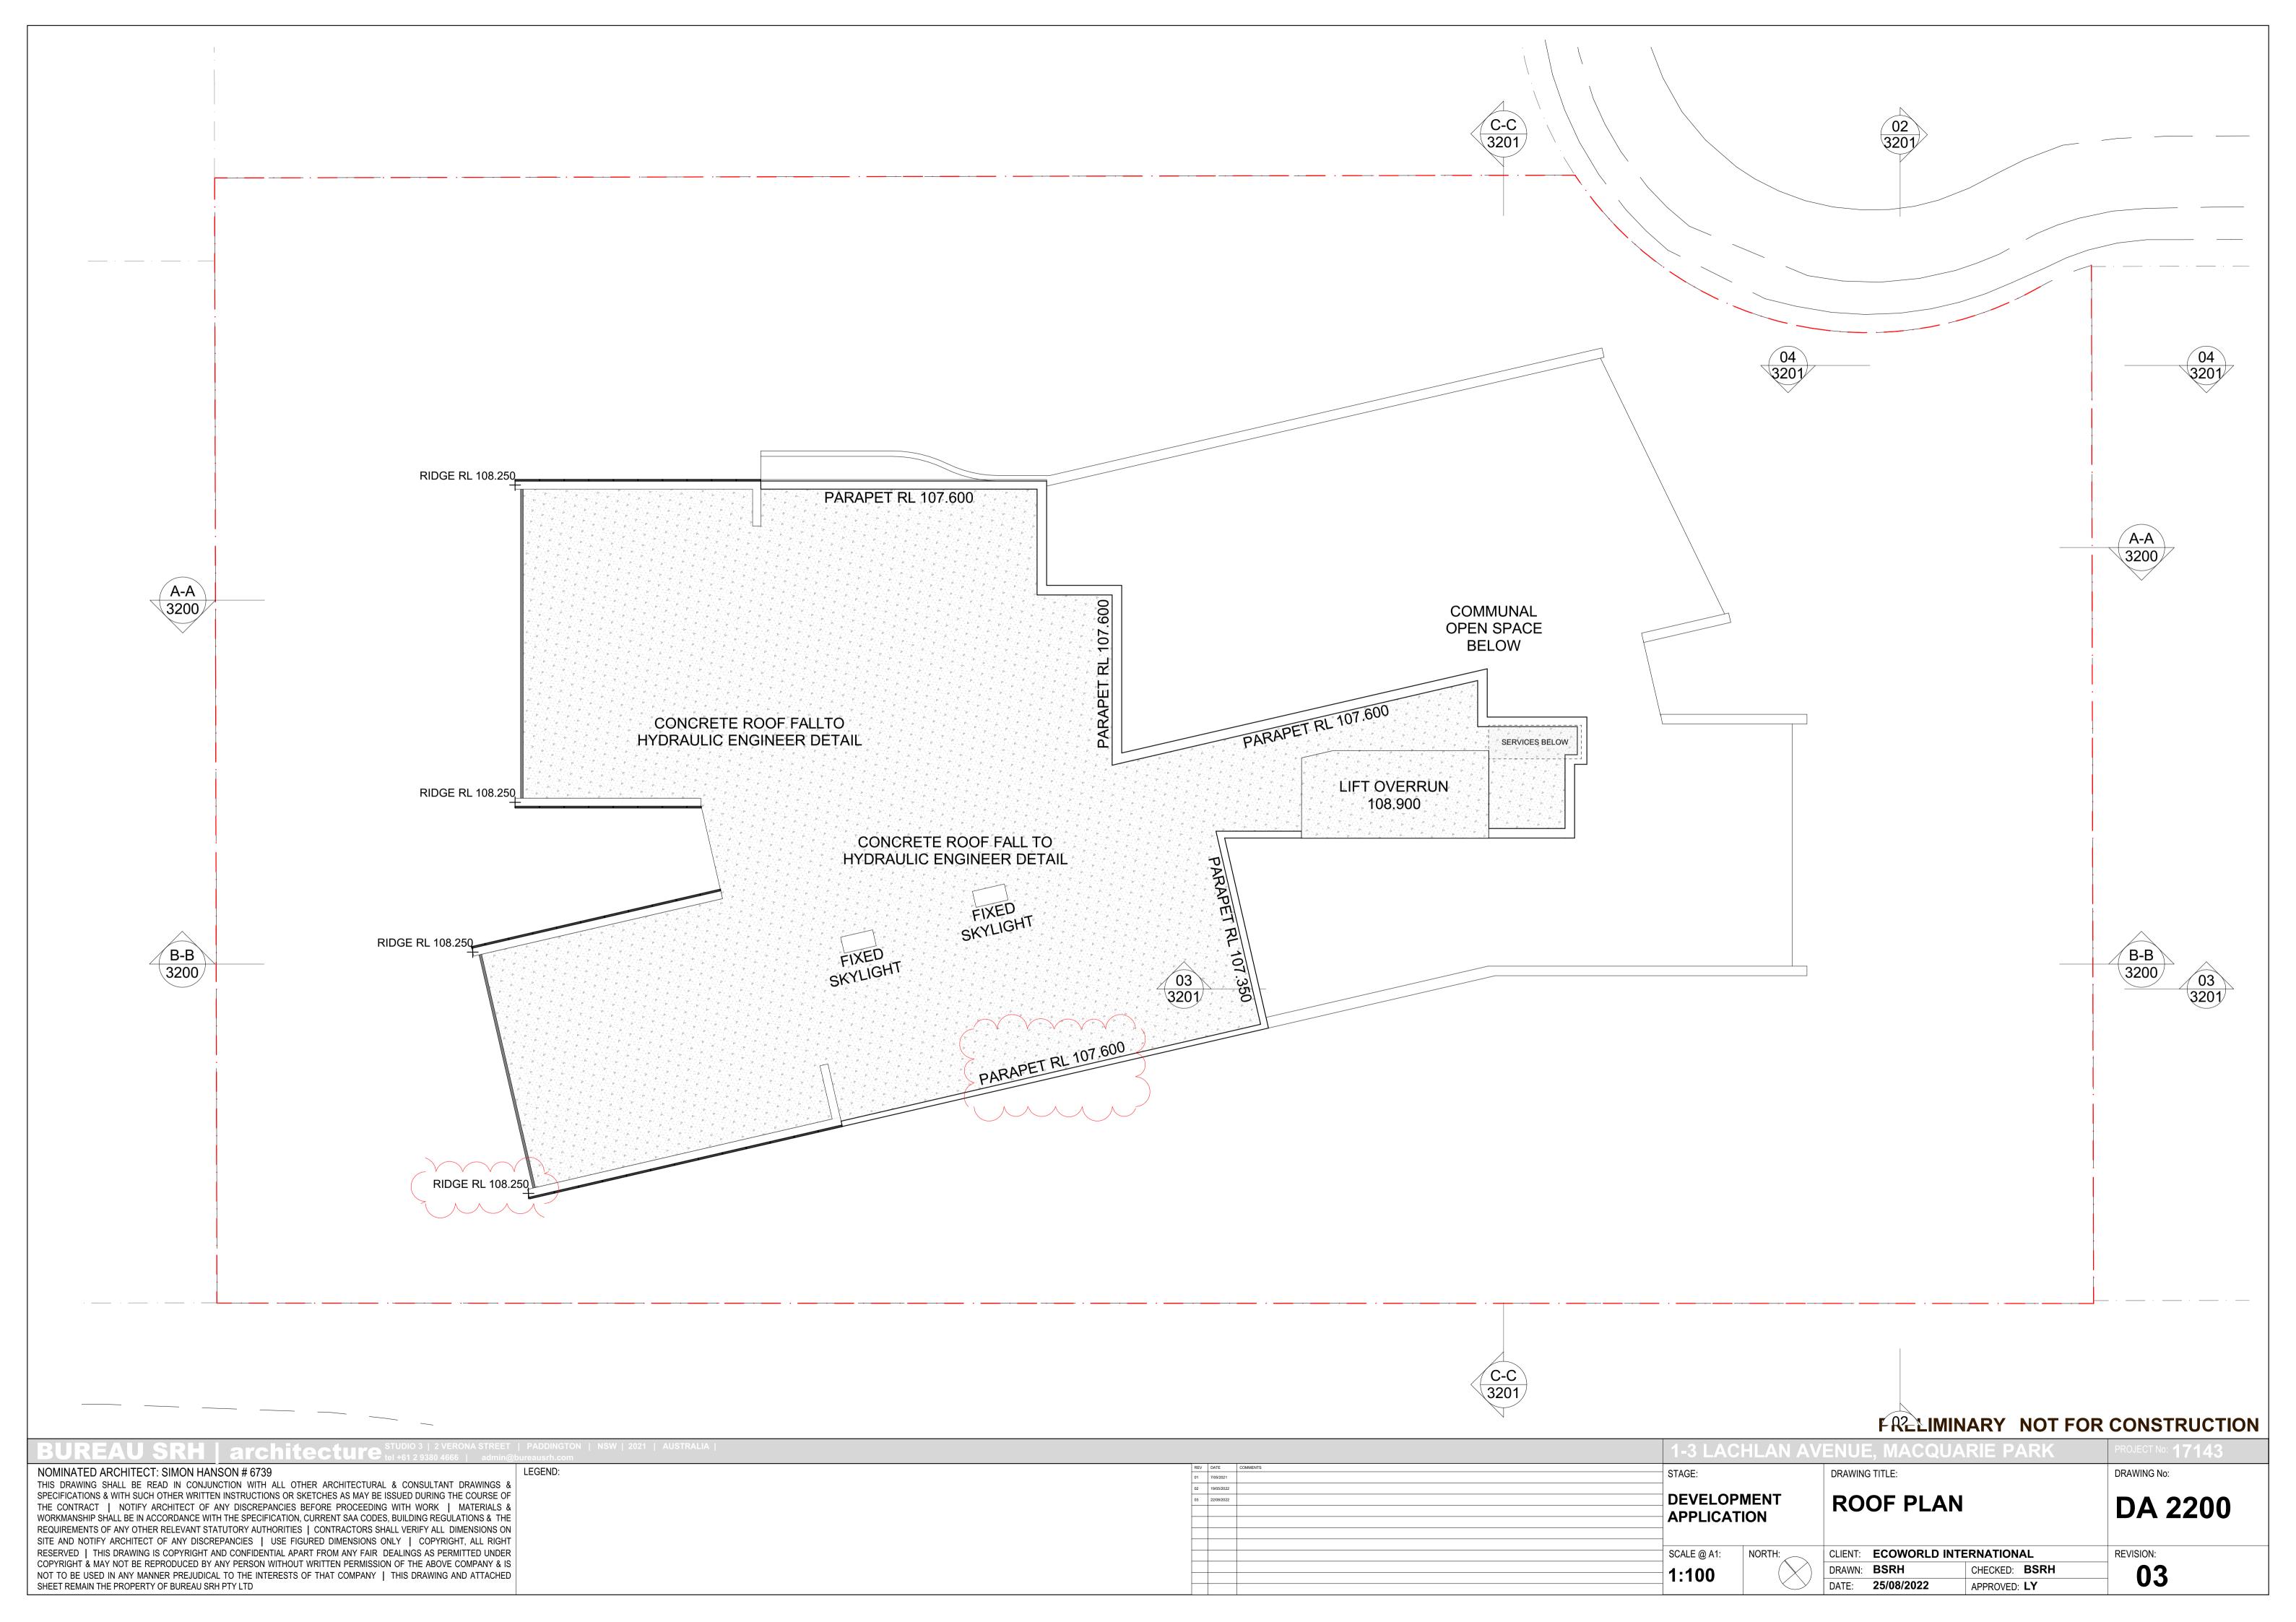


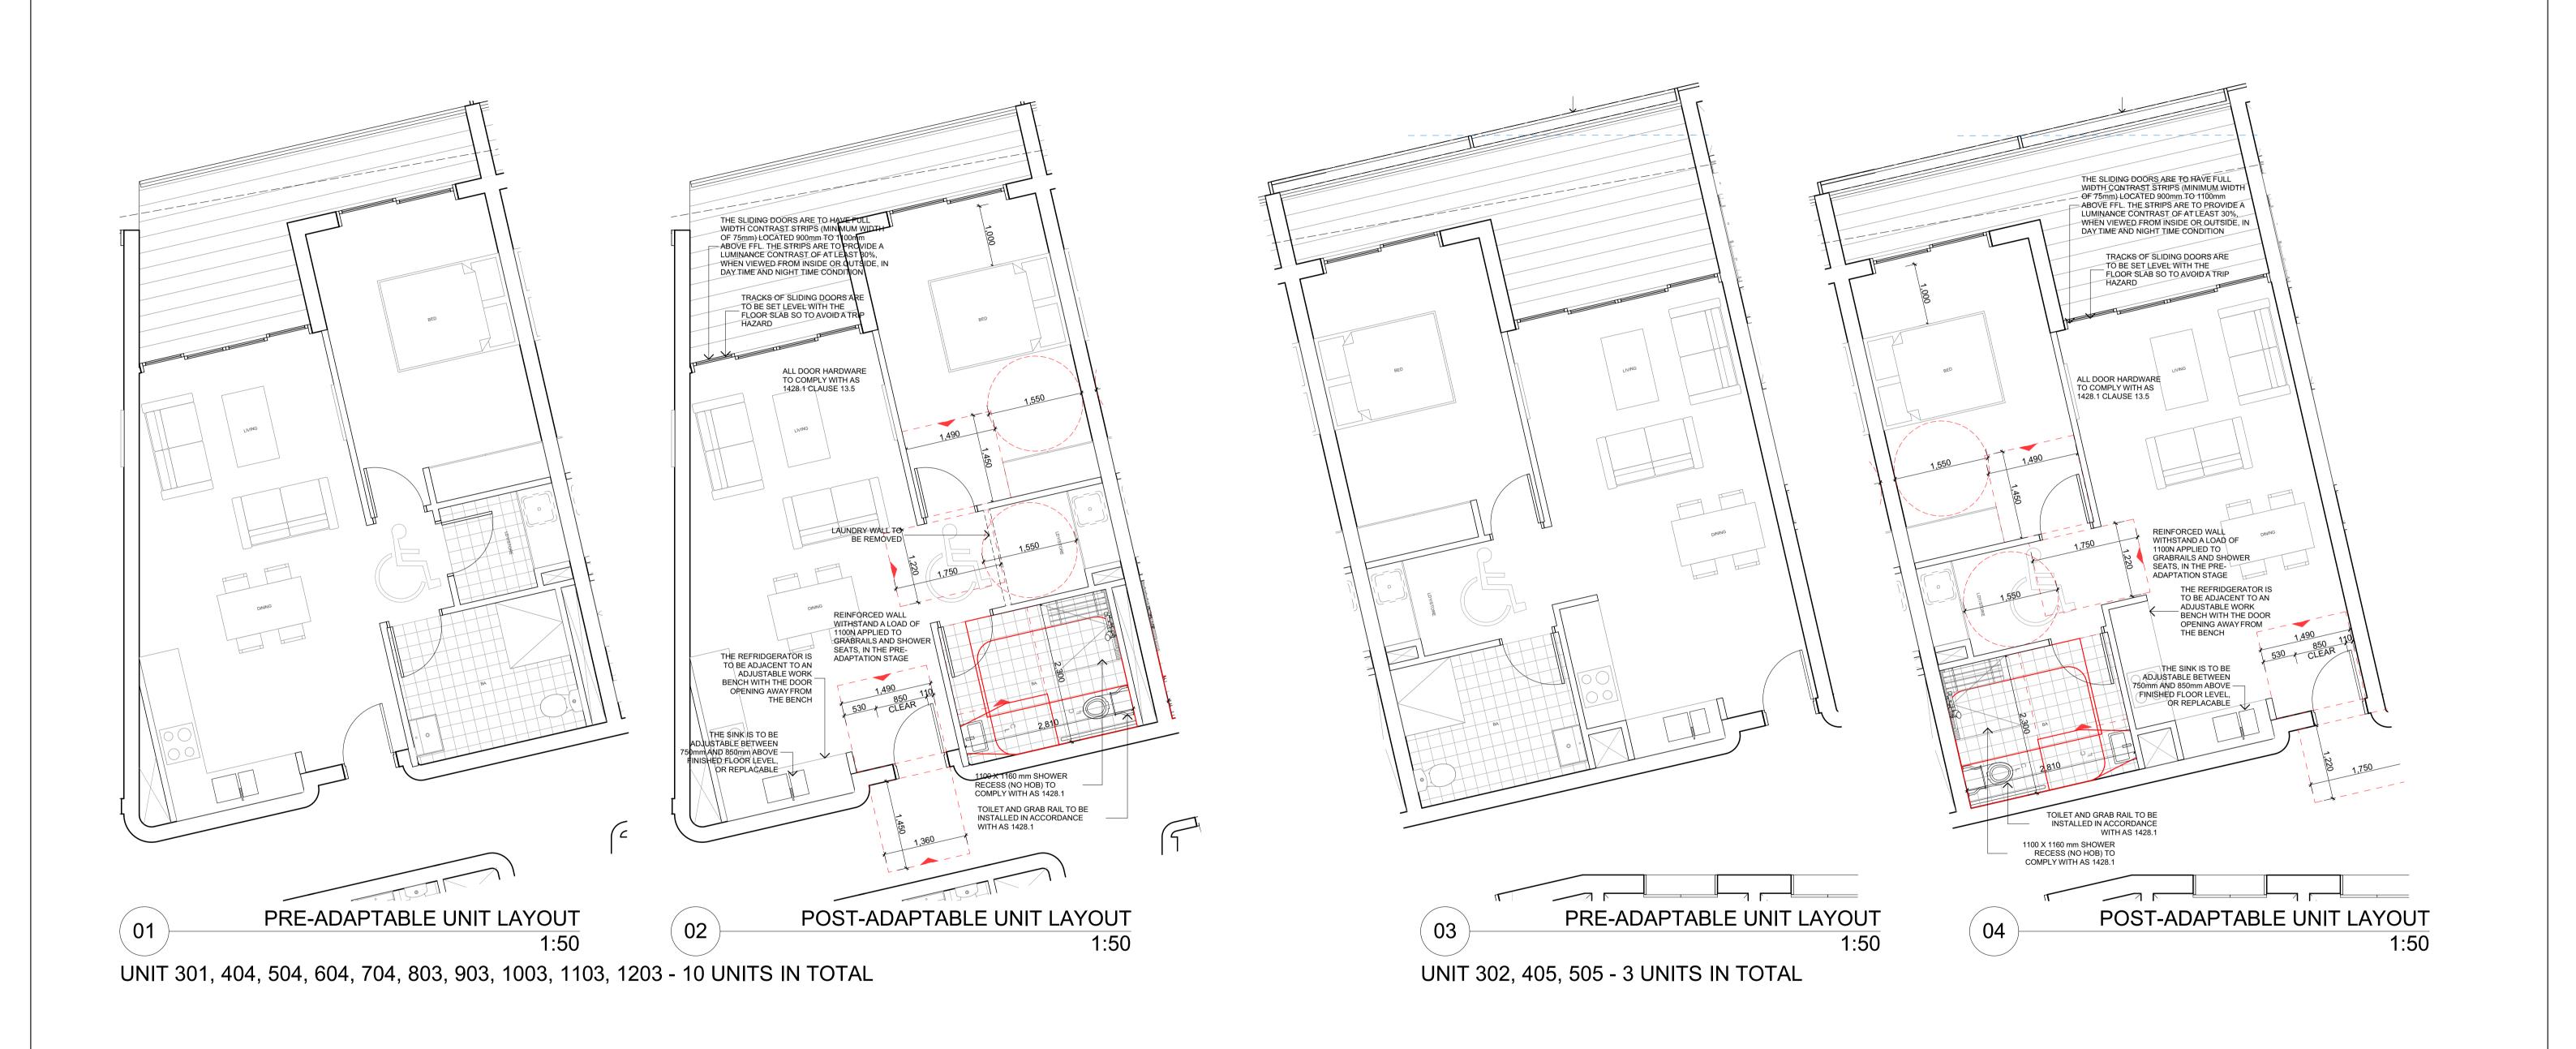










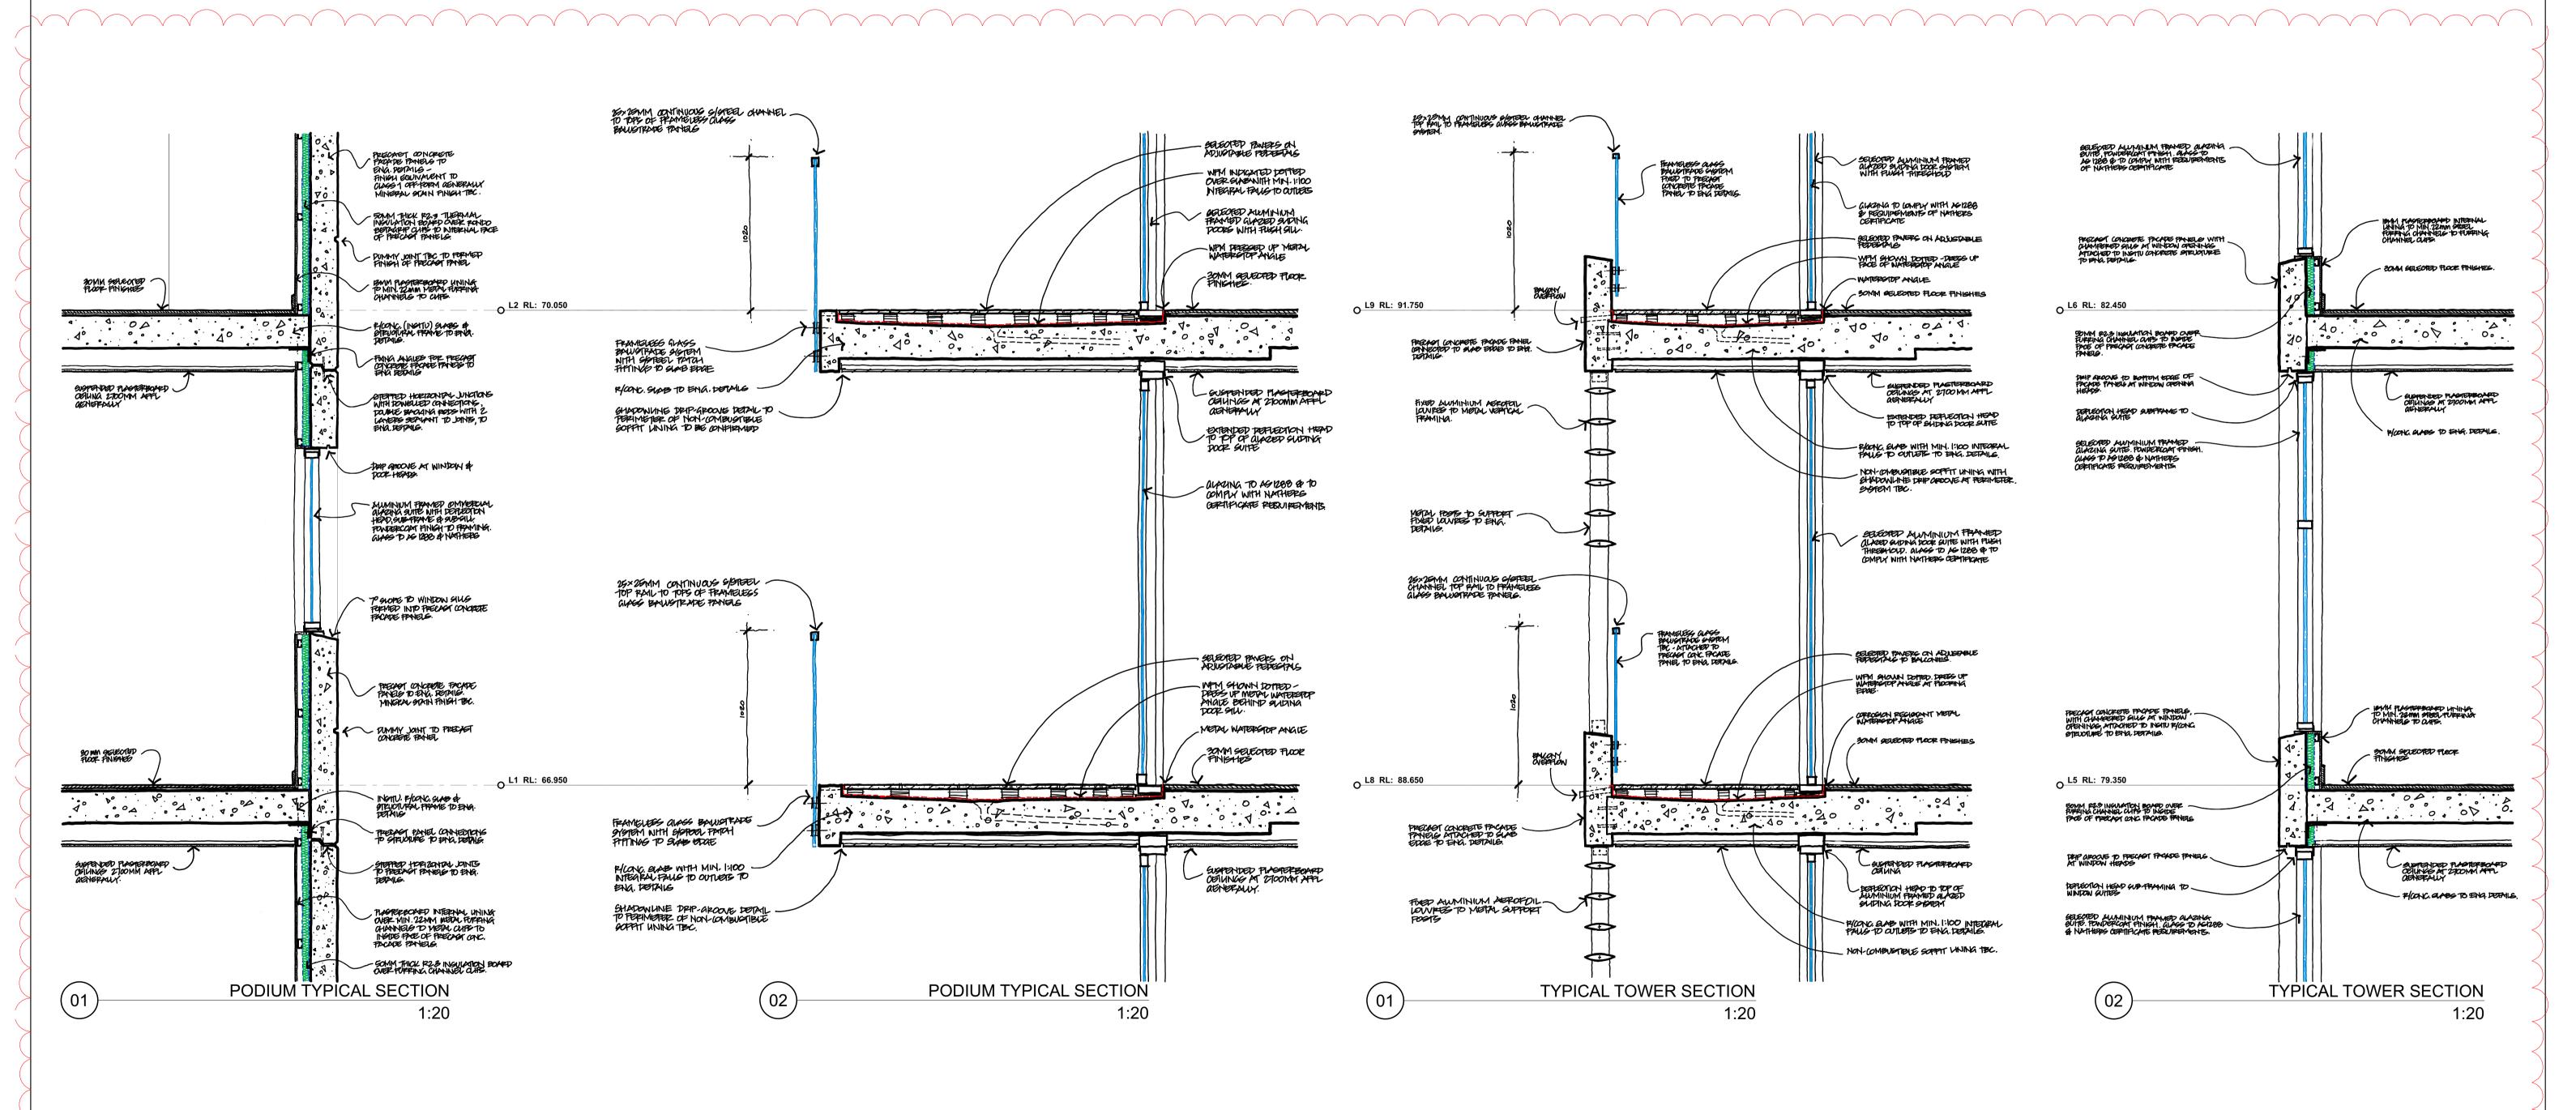


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The 1:20 detail plans shall incorporate the proposed 'timber look balustrade.'

Downpipe locations shall be integrated into walls and not left exposed.

Air conditioning condenser units located on balconies shall be screened and treated for noise attenuation.

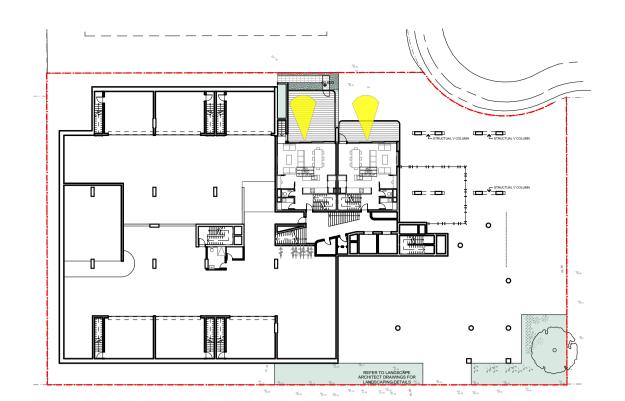


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BUREAU SRH architecture STUDIO 3 2 VERONA STREET tel +61 2 9380 4666 admin@	PADDINGTON NSW 2021 AUSTRALIA Dureausrh.com	1-3 LACHLAN AV	ENUE, MACQUARIE PARK	PROJECT No: 17143
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	•			







SOLAR ACCESS DIAGRAM - MEZZANINE



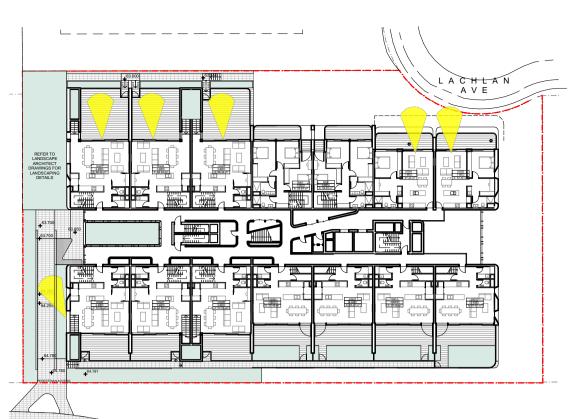
SOLAR ACCESS DIAGRAM - L3



SOLAR ACCESS DIAGRAM - L7



SOLAR ACCESS DIAGRAM - L11



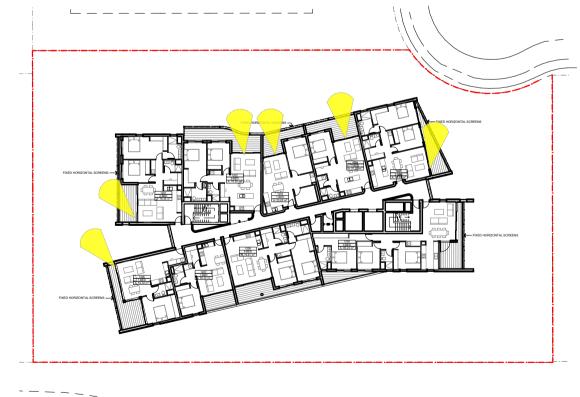
SOLAR ACCESS DIAGRAM - UPPER GROUND



SOLAR ACCESS DIAGRAM - L4



SOLAR ACCESS DIAGRAM - L8



SOLAR ACCESS DIAGRAM - L12



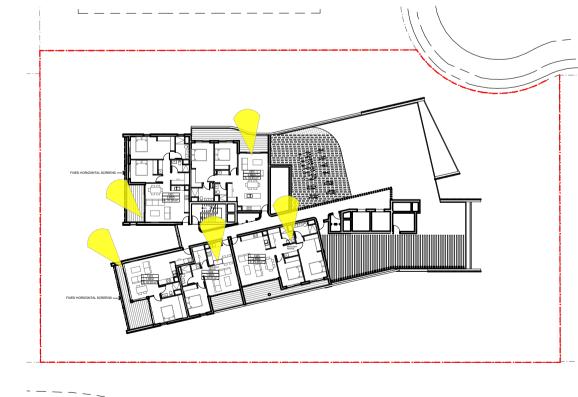
SOLAR ACCESS DIAGRAM - L1



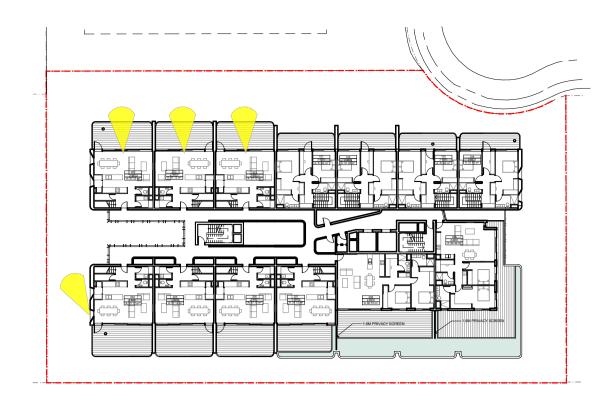
SOLAR ACCESS DIAGRAM - L5



SOLAR ACCESS DIAGRAM - L9



SOLAR ACCESS DIAGRAM - L13



SOLAR ACCESS DIAGRAM - L2



SOLAR ACCESS DIAGRAM - L6



SOLAR ACCESS DIAGRAM - L10

A MEZZANINE O LIDDED	CDOLIND		
11. MEZZANINE & UPPER	M01	3-BED	Y
2. UPPER GROUND & LE		3-BED	Y Y
	UG01 UG02	3-BED 3-BED	Y
	UG03 UG04	3-BED 1-BED	Y
	UG05 UG06	1-BED 3-BED	Y
	UG07 UG08	3-BED 3-BED	
	UG09 UG10	2-BED 2-BED	
	UG11 UG12	2-BED 2-BED	
3. LEVEL 1 & LEVEL 2	101	2-BED	Y
	102 103	2-BED 2-BED 2-BED	Y
4 15/51 2 8 15/51 2	103	2-BED	Y
4. LEVEL 2 & LEVEL 3	201	2-BED	Y
	202 203	2-BED 2-BED	Y
	204 205	2-BED 2-BED	Y
	206 207	2-BED 2-BED	
5. LEVEL 2	208	2-BED	
6. LEVEL 3	209	2-BED	
	301 302	1-BED 1-BED	Y
	303 304	2-BED 2-BED	Y
7. LEVEL 4	305	2-BED	Y
, . LL v LL T	401 402	1-BED	Y
	403	2-BED 2-BED	Y
	404 405	1-BED 1-BED	Y
	406 407	2-BED 3-BED	Y
	408 409	2-BED 2-BED	
8. LEVEL 5	410	2-BED	Y
	501 502	1-BED 1-BED	Y
	503 504	2-BED 1-BED	Y Y
	505 506	1-BED 2-BED	Y
	507 508	3-BED 2-BED	Y
	509	2-BED	\ \ \ \ \ \ \ \ \ \ \ \ \ \ \ \ \ \ \
9. LEVEL 6	510	2-BED	Y
	601 602	1-BED 1-BED	Y
	603 604	2-BED 1-BED	Y
	605 606	1-BED 2-BED	Y
	607 608	3-BED 2-BED	Y
	609 610	2-BED 2-BED	Y
0. LEVEL 7	701	1-BED	Y
	702 703	1-BED 1-BED 2-BED	Y
	704	1-BED	Y
	705 706	1-BED 2-BED	Y
	707 708	1-BED 1-BED	Y
	709 710	2-BED 2-BED	
1. LEVEL 8	711	2-BED	Y
	801 802	2-BED 2-BED	Y
	803 804	1-BED 1-BED	Y Y
	805 806	2-BED 1-BED	Y
	807 808	1-BED 1-BED 2-BED	
2 1 5 / 5 2	808	2-BED 3-BED	
2. LEVEL 9	901	2-BED	Y
	902 903	2-BED 1-BED	Y
	904 905	1-BED 2-BED	Y
	906 907	1-BED 1-BED	Ý
	908 909	2-BED 3-BED	
3. LEVEL 10	1001	2-BED	Y
	1002	2-BED	Y
	1003 1004	1-BED 1-BED	Y
	1005 1006	2-BED 1-BED	Y
	1007 1008	1-BED 2-BED	
4. LEVEL 11	1009	3-BED	
	1101 1102	2-BED 2-BED	Y
	1103 1104	1-BED 1-BED	Y
	1104 1105 1106	2-BED 1-BED	Y
	1106 1107 1108	1-BED 1-BED 2-BED	T T
5 LEVEL 40	1108 1109	2-BED 3-BED	
5. LEVEL 12	1201	2-BED	Y
	1202 1203	2-BED 1-BED	Y
	1204 1205	1-BED 2-BED	Y
	1206 1207	1-BED 1-BED	Ý
	1208 1209	2-BED 3-BED	
6. LEVEL 13	1301	2-BED	Т Y
	1302 1303	2-BED 2-BED 1-BED	Y
	1304	1-BED	Y
	1305	2-BED	Y

001U UNIT SCHEDULE copy 1

UNIT SCHEDULE LEVELS UNIT

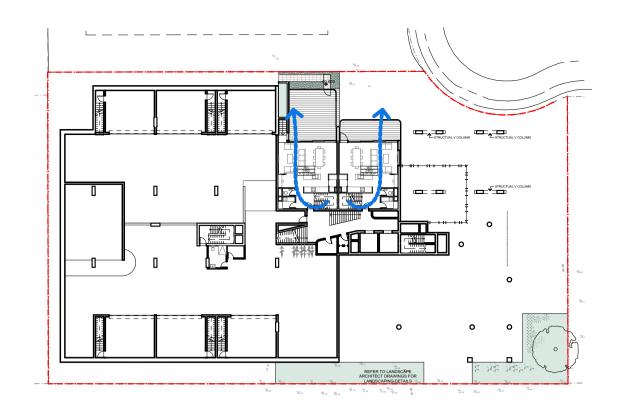
BEDROOMS

SOLAR ACCESS

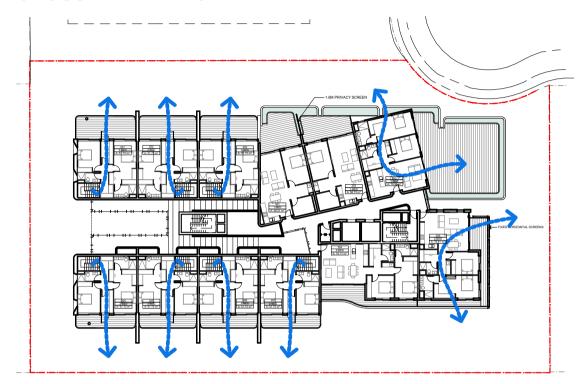
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DATE: **25/08/2022**

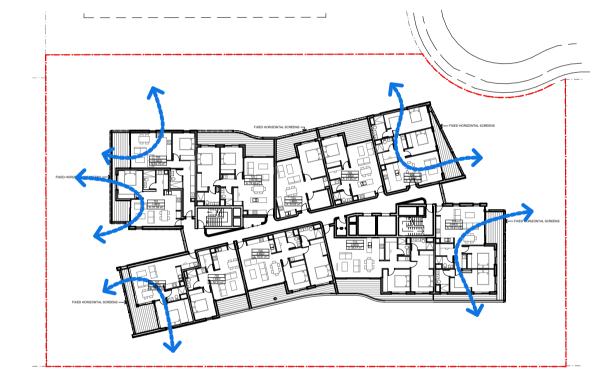
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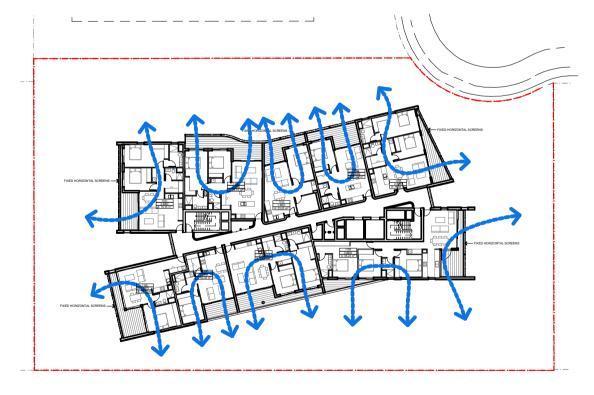
CROSS VENTILATION - MEZZANINE



CROSS VENTILATION - L3



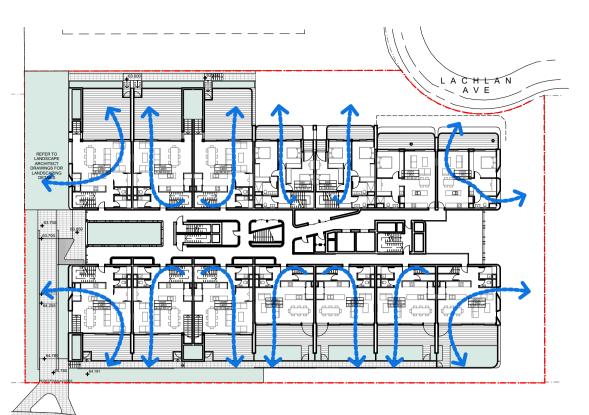
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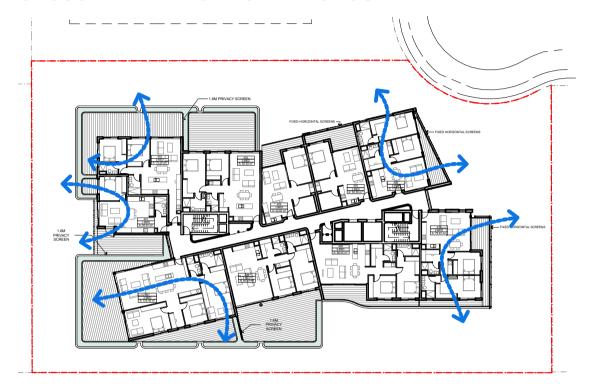
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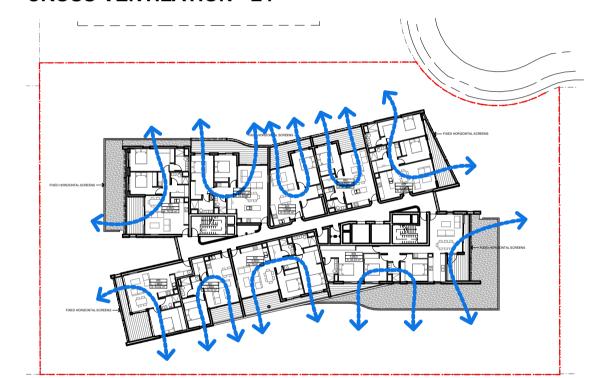
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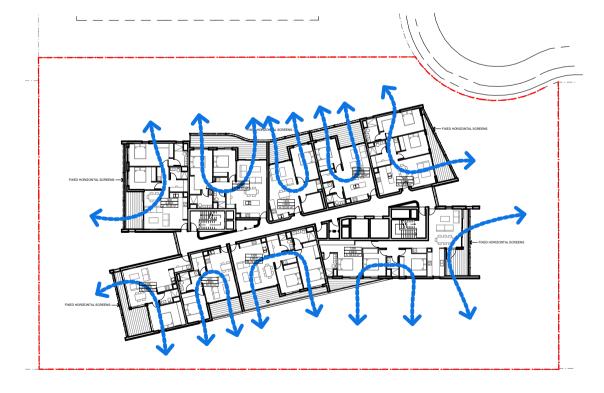
CROSS VENTILATION - UPPER GROUND



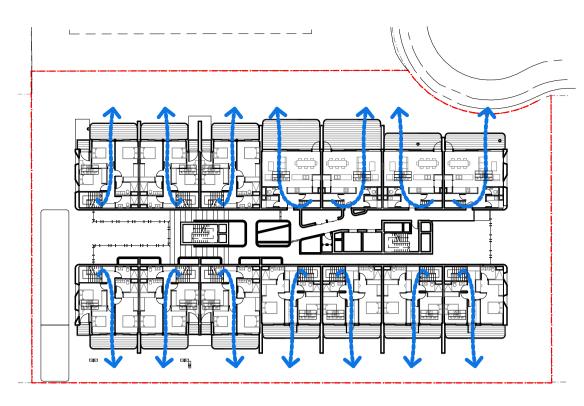
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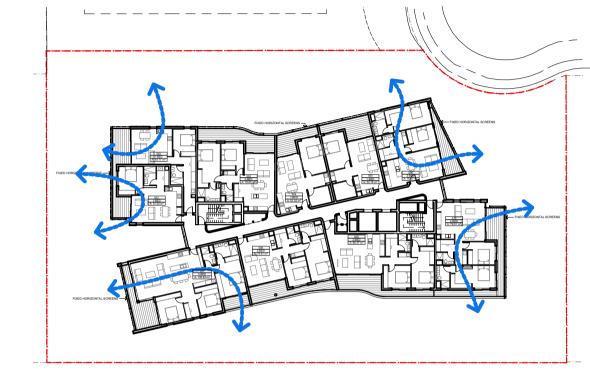
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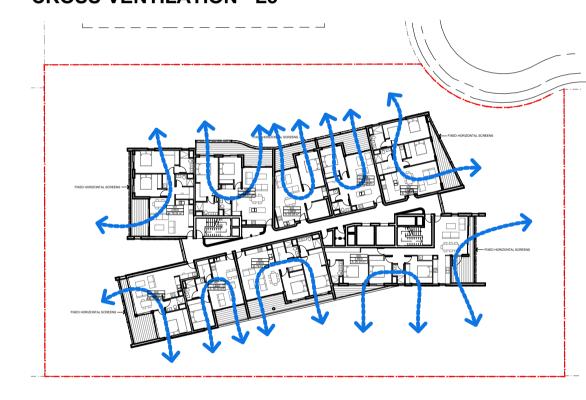
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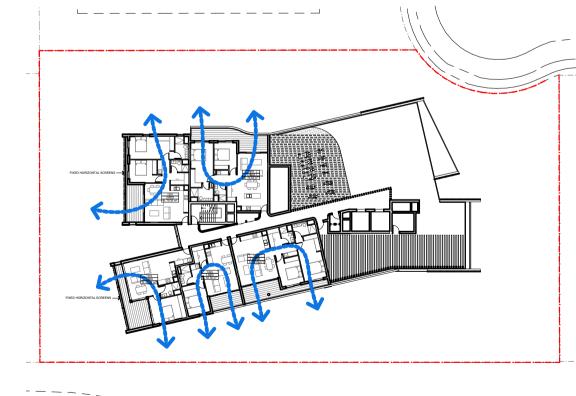
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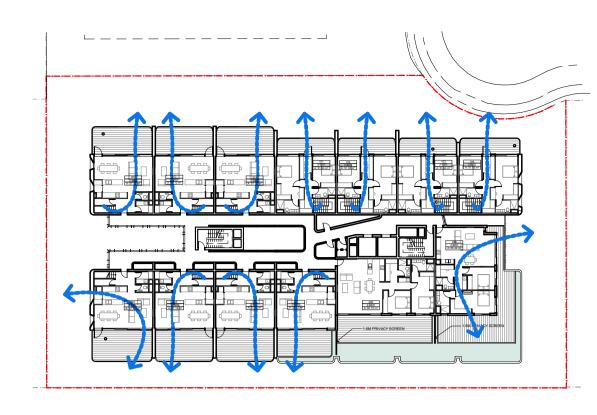
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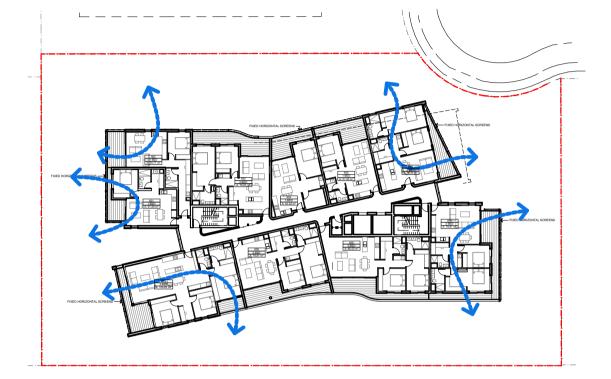
CROSS VENTILATION - L9



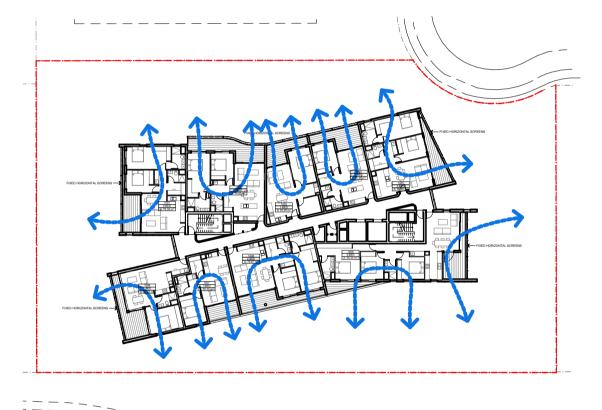
CROSS VENTILATION - L13



CROSS VENTILATION - L2



CROSS VENTILATION - L6



CROSS VENTILATION - L10

02. UPPER GROUND & LEV		3-BED	Y
	UG01 UG02	3-BED 3-BED	Y
	UG03 UG04	3-BED 1-BED	Y
	UG05 UG06	1-BED 3-BED	Y
	UG07 UG08	3-BED 3-BED	Y
	UG09 UG10	2-BED 2-BED	Y
00 15/51 2 0 15/51	UG11 UG12	2-BED 2-BED	Y
03. LEVEL 1 & LEVEL 2	101	2-BED	Y
	102 103	2-BED 2-BED	Y
04. LEVEL 2 & LEVEL 3	104	2-BED	Y
	201 202	2-BED 2-BED	Y
	203 204 205	2-BED 2-BED 2-BED	Y
	205 206 207	2-BED 2-BED 2-BED	Y
05. LEVEL 2	208	2-BED	
06. LEVEL 3	209	2-BED	Y
00. 22.722.0	301 302	1-BED 1-BED	
	303 304	2-BED 2-BED	Y
07. LEVEL 4	305	2-BED	Υ
·	401 402	1-BED 2-BED	Y
	403 404	2-BED 1-BED	
	405 406	1-BED 2-BED	Y
	407 408	3-BED 2-BED	Y
	409 410	2-BED 2-BED	Y
08. LEVEL 5	501	1-BED	Y
	502 503	1-BED 2-BED	Y
	504 505	1-BED 1-BED	
	506 507	2-BED 3-BED	Y
	508 509	2-BED 2-BED	
09. LEVEL 6	510	2-BED	Y
	601 602	1-BED 1-BED	Y
	603 604	2-BED 1-BED	
	605 606	1-BED 2-BED	Y
	607 608	3-BED 2-BED	Y
40 15/51 7	609 610	2-BED 2-BED	Y
10. LEVEL 7	701	1-BED	Y
	702 703 704	1-BED 2-BED	Y
	704 705 706	1-BED 1-BED 2-BED	Y
	706 707 708	1-BED 1-BED	Y
	709 710	2-BED 2-BED 2-BED	
11. LEVEL 8	711	2-BED	Y
-	801 802	2-BED 2-BED	Y
	803 804	1-BED 1-BED	Y
	805 806	2-BED 1-BED	Y
	807 808	1-BED 2-BED	Y
12. LEVEL 9	809	3-BED	Y
	901 902	2-BED 2-BED	Y
	903 904	1-BED 1-BED	Y Y
	905 906	2-BED 1-BED	Y
	907 908	1-BED 2-BED	Y
13. LEVEL 10	909	3-BED	Y
	1001 1002	2-BED 2-BED	Y
	1003 1004	1-BED 1-BED	Y
	1005 1006	2-BED 1-BED	Y
	1007 1008	1-BED 2-BED	Y
14. LEVEL 11	1009	3-BED	Y
	1101 1102	2-BED 2-BED	Y
	1103 1104	1-BED 1-BED	Y
	1105 1106	2-BED 1-BED	Y
	1107 1108	1-BED 2-BED	Y
15. LEVEL 12	1109	3-BED	Y
	1201 1202	2-BED 2-BED	Y
	1203 1204 1205	1-BED 1-BED	Y
	1205 1206 1207	2-BED 1-BED	Y
	1207 1208 1209	1-BED 2-BED 3-BED	Y
16. LEVEL 13	1301	2-BED	Y Y
	1301 1302 1303	2-BED 2-BED 1-BED	Y
	1304	1-BED	Υ
	1305	2-BED	l Y

UNIT SCHEDULE LEVELS UNIT

BEDROOMS

CROSS VENT

PRELIMINARY NOT FOR CONSTRUCTION

CHECKED: **BSRH**

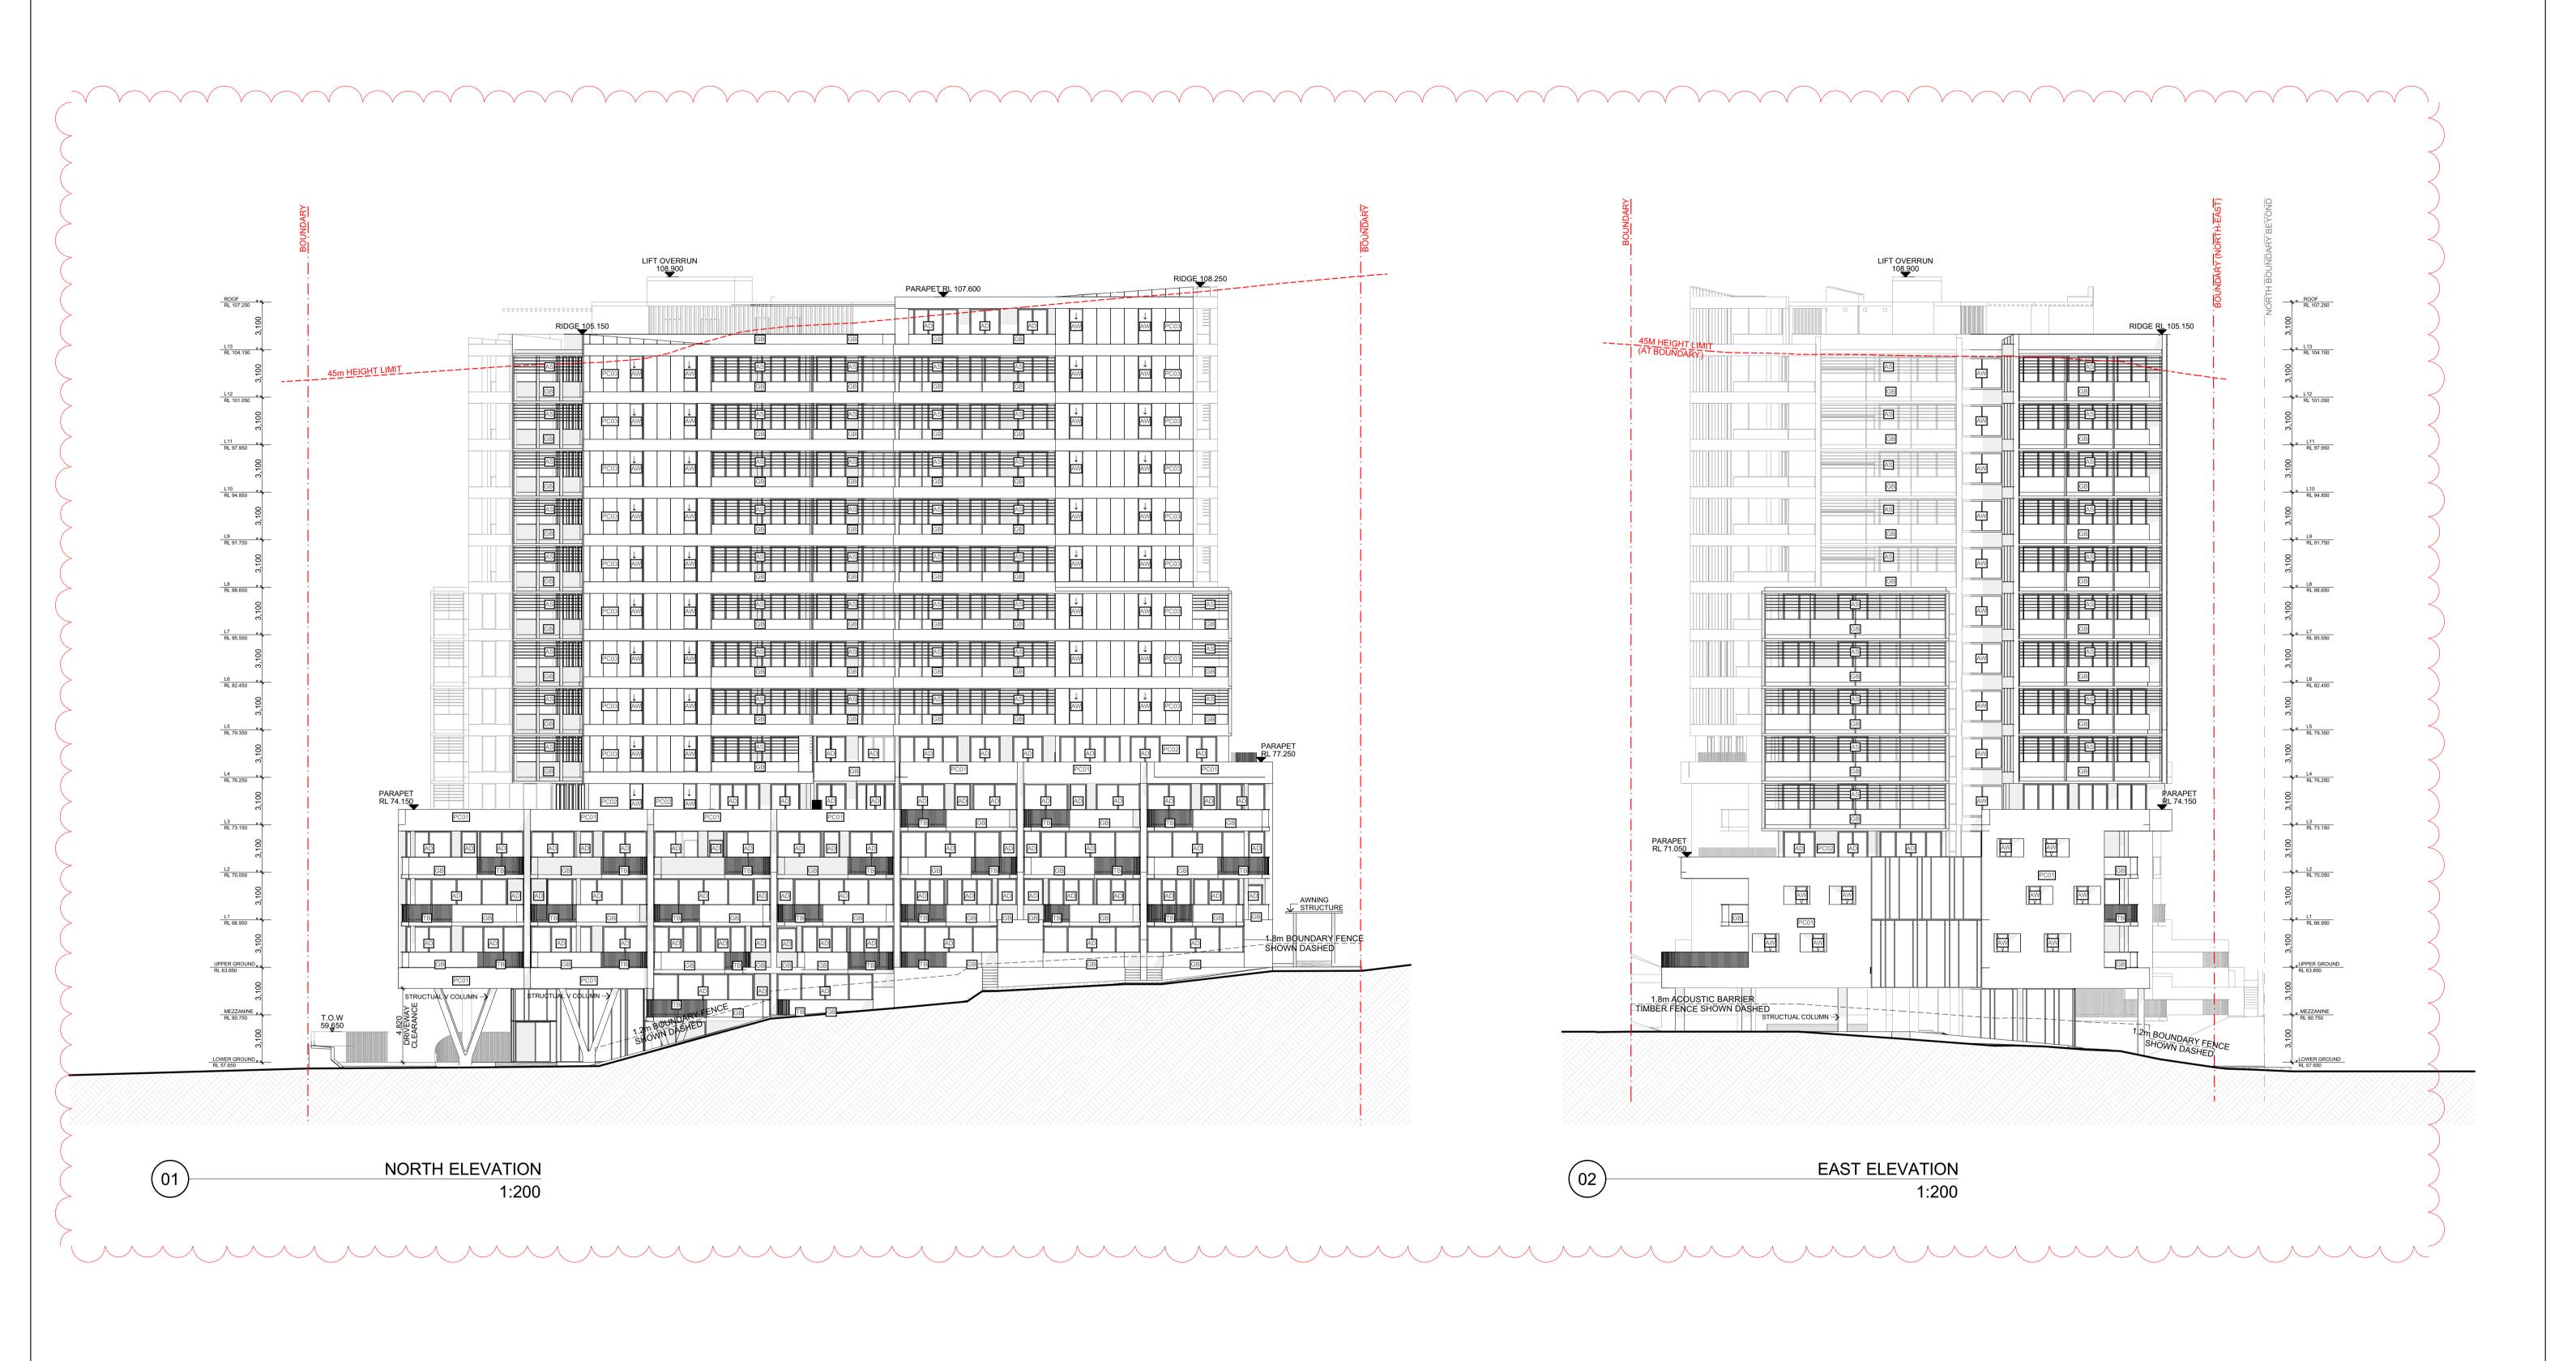
APPROVED: LY

DRAWN: **BSRH**

DATE: **25/08/2022**

1:500

BUREAU SRH | architecture STUDIO 3 | 2 VERONA STREET | PADDINGTON | NSW | 2021 | AUSTRALIA | 1-3 LACHLAN AVENUE, MACQUARIE PARK NOMINATED ARCHITECT: SIMON HANSON # 6739 STAGE: DRAWING TITLE: DRAWING No: THIS DRAWING SHALL BE READ IN CONJUNCTION WITH ALL OTHER ARCHITECTURAL & CONSULTANT DRAWINGS & SPECIFICATIONS & WITH SUCH OTHER WRITTEN INSTRUCTIONS OR SKETCHES AS MAY BE ISSUED DURING THE COURSE OF **DEVELOPMENT CROSS VENTILATION DA 2502** ← → UNIT ACHIEVING CROSS VENTILATION THE CONTRACT | NOTIFY ARCHITECT OF ANY DISCREPANCIES BEFORE PROCEEDING WITH WORK | MATERIALS & **APPLICATION** WORKMANSHIP SHALL BE IN ACCORDANCE WITH THE SPECIFICATION, CURRENT SAA CODES, BUILDING REGULATIONS & THE **DIAGRAM** REQUIREMENTS OF ANY OTHER RELEVANT STATUTORY AUTHORITIES | CONTRACTORS SHALL VERIFY ALL DIMENSIONS ON SITE AND NOTIFY ARCHITECT OF ANY DISCREPANCIES | USE FIGURED DIMENSIONS ONLY | COPYRIGHT, ALL RIGHT RESERVED | THIS DRAWING IS COPYRIGHT AND CONFIDENTIAL APART FROM ANY FAIR DEALINGS AS PERMITTED UNDER CLIENT: ECOWORLD INTERNATIONAL REVISION: SCALE @ A1:



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SANDSTONE COLOUR OR SIMILAR

DARK GREY COLOUR OR SIMILAR

WHITE COLOUR OR SIMILAR TS - FIXED TIMBER LOOKING PRIVACY SCREENS GB - GLASS BALUSTRADE G - GLASS CURTAIN WALL AD - ALUMINUM DOOR

F - FIXED

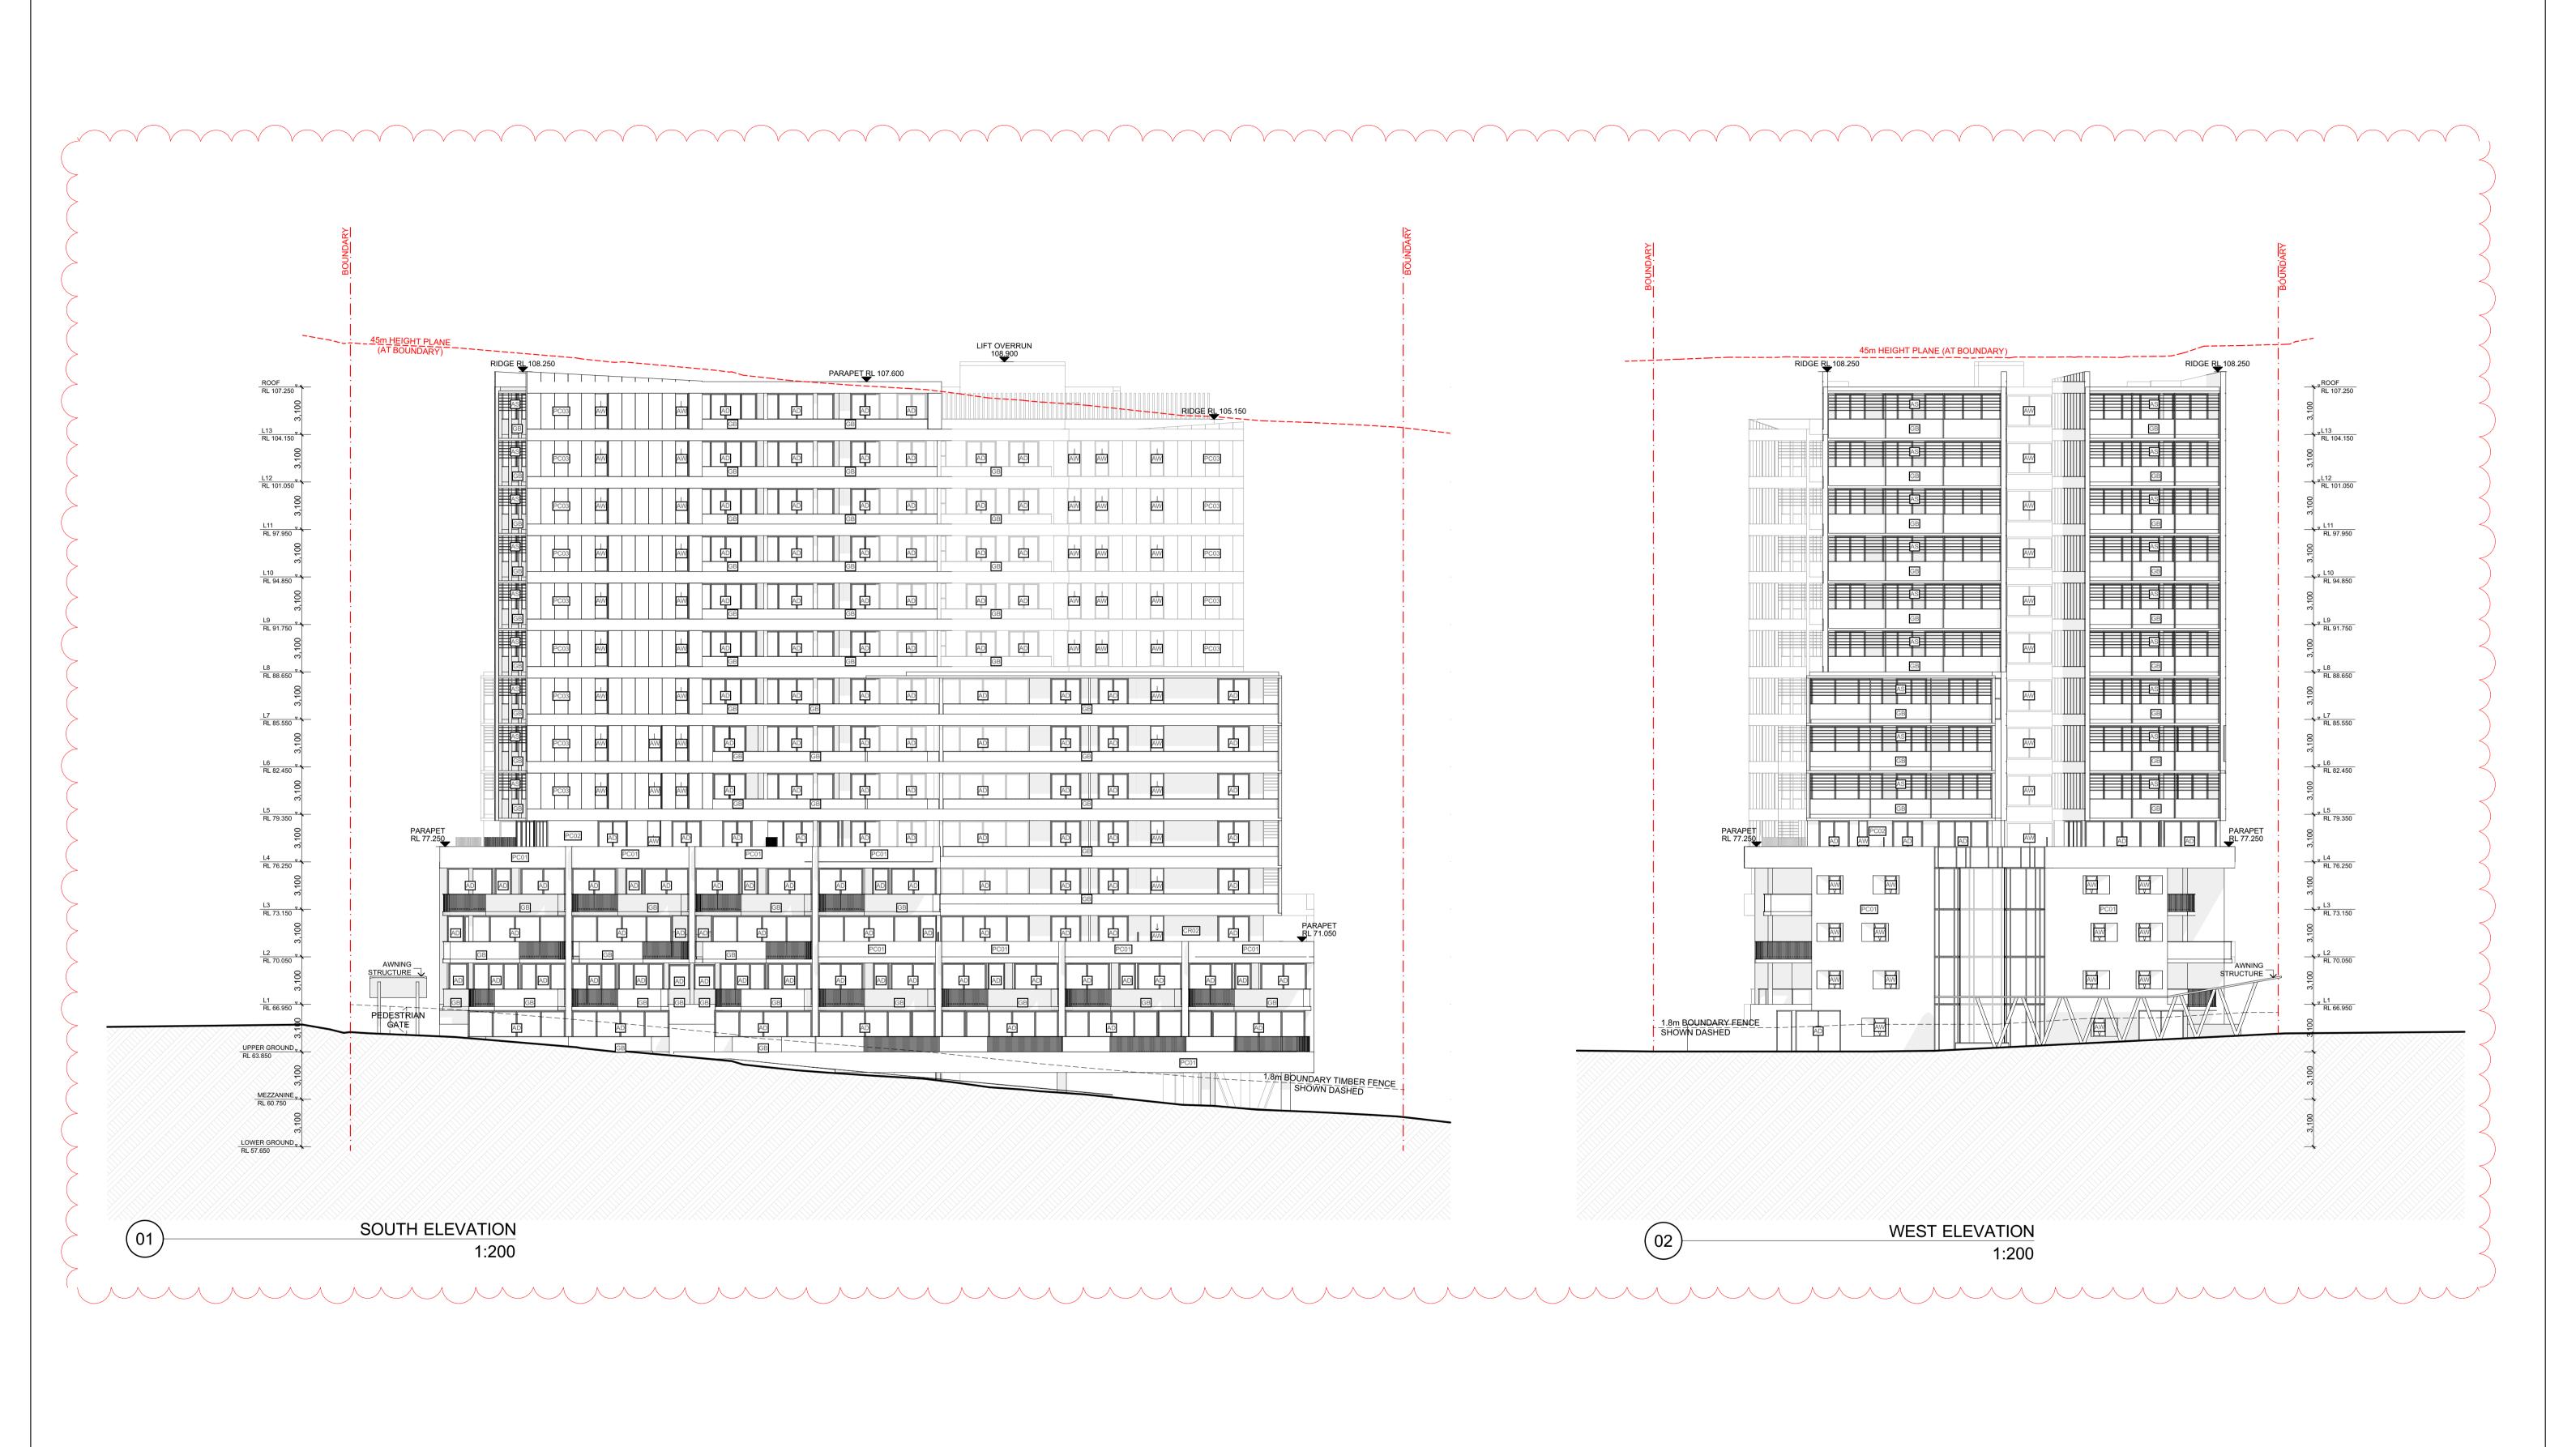
AW - ALUMINUM WINDOW S - TIMBER LOOKING SOFFIT

	1-3 LACI	HLAN A
WTS	STAGE:	
	DEVELOP	MENT
	APPLICATI	ON
	SCALE @ A1:	NORTH:

1:200

VENUE, MACQUARIE PARK OJECT No: **17143** DRAWING TITLE: DRAWING No: ELEVATIONS - NORTH & DA 3100 **EAST**

CLIENT: **ECOWORLD INTERNATIONAL** REVISION: DRAWN: **BSRH** CHECKED: **BSRH** 03 DATE: **25/08/2022** APPROVED: LY



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SANDSTONE COLOUR OR SIMILAR

DARK GREY COLOUR OR SIMILAR

WHITE COLOUR OR SIMILAR TS - FIXED TIMBER LOOKING PRIVACY SCREENS GB - GLASS BALUSTRADE G - GLASS CURTAIN WALL

F - FIXED

AD - ALUMINUM DOOR **AW - ALUMINUM WINDOW**

COMMENTS	STAGE:	
	DEVELOR	MENIT
	DEVELOPMENT APPLICATION	
	AFFLICAT	IOIN
	SCALE @ A1:	NORTH:

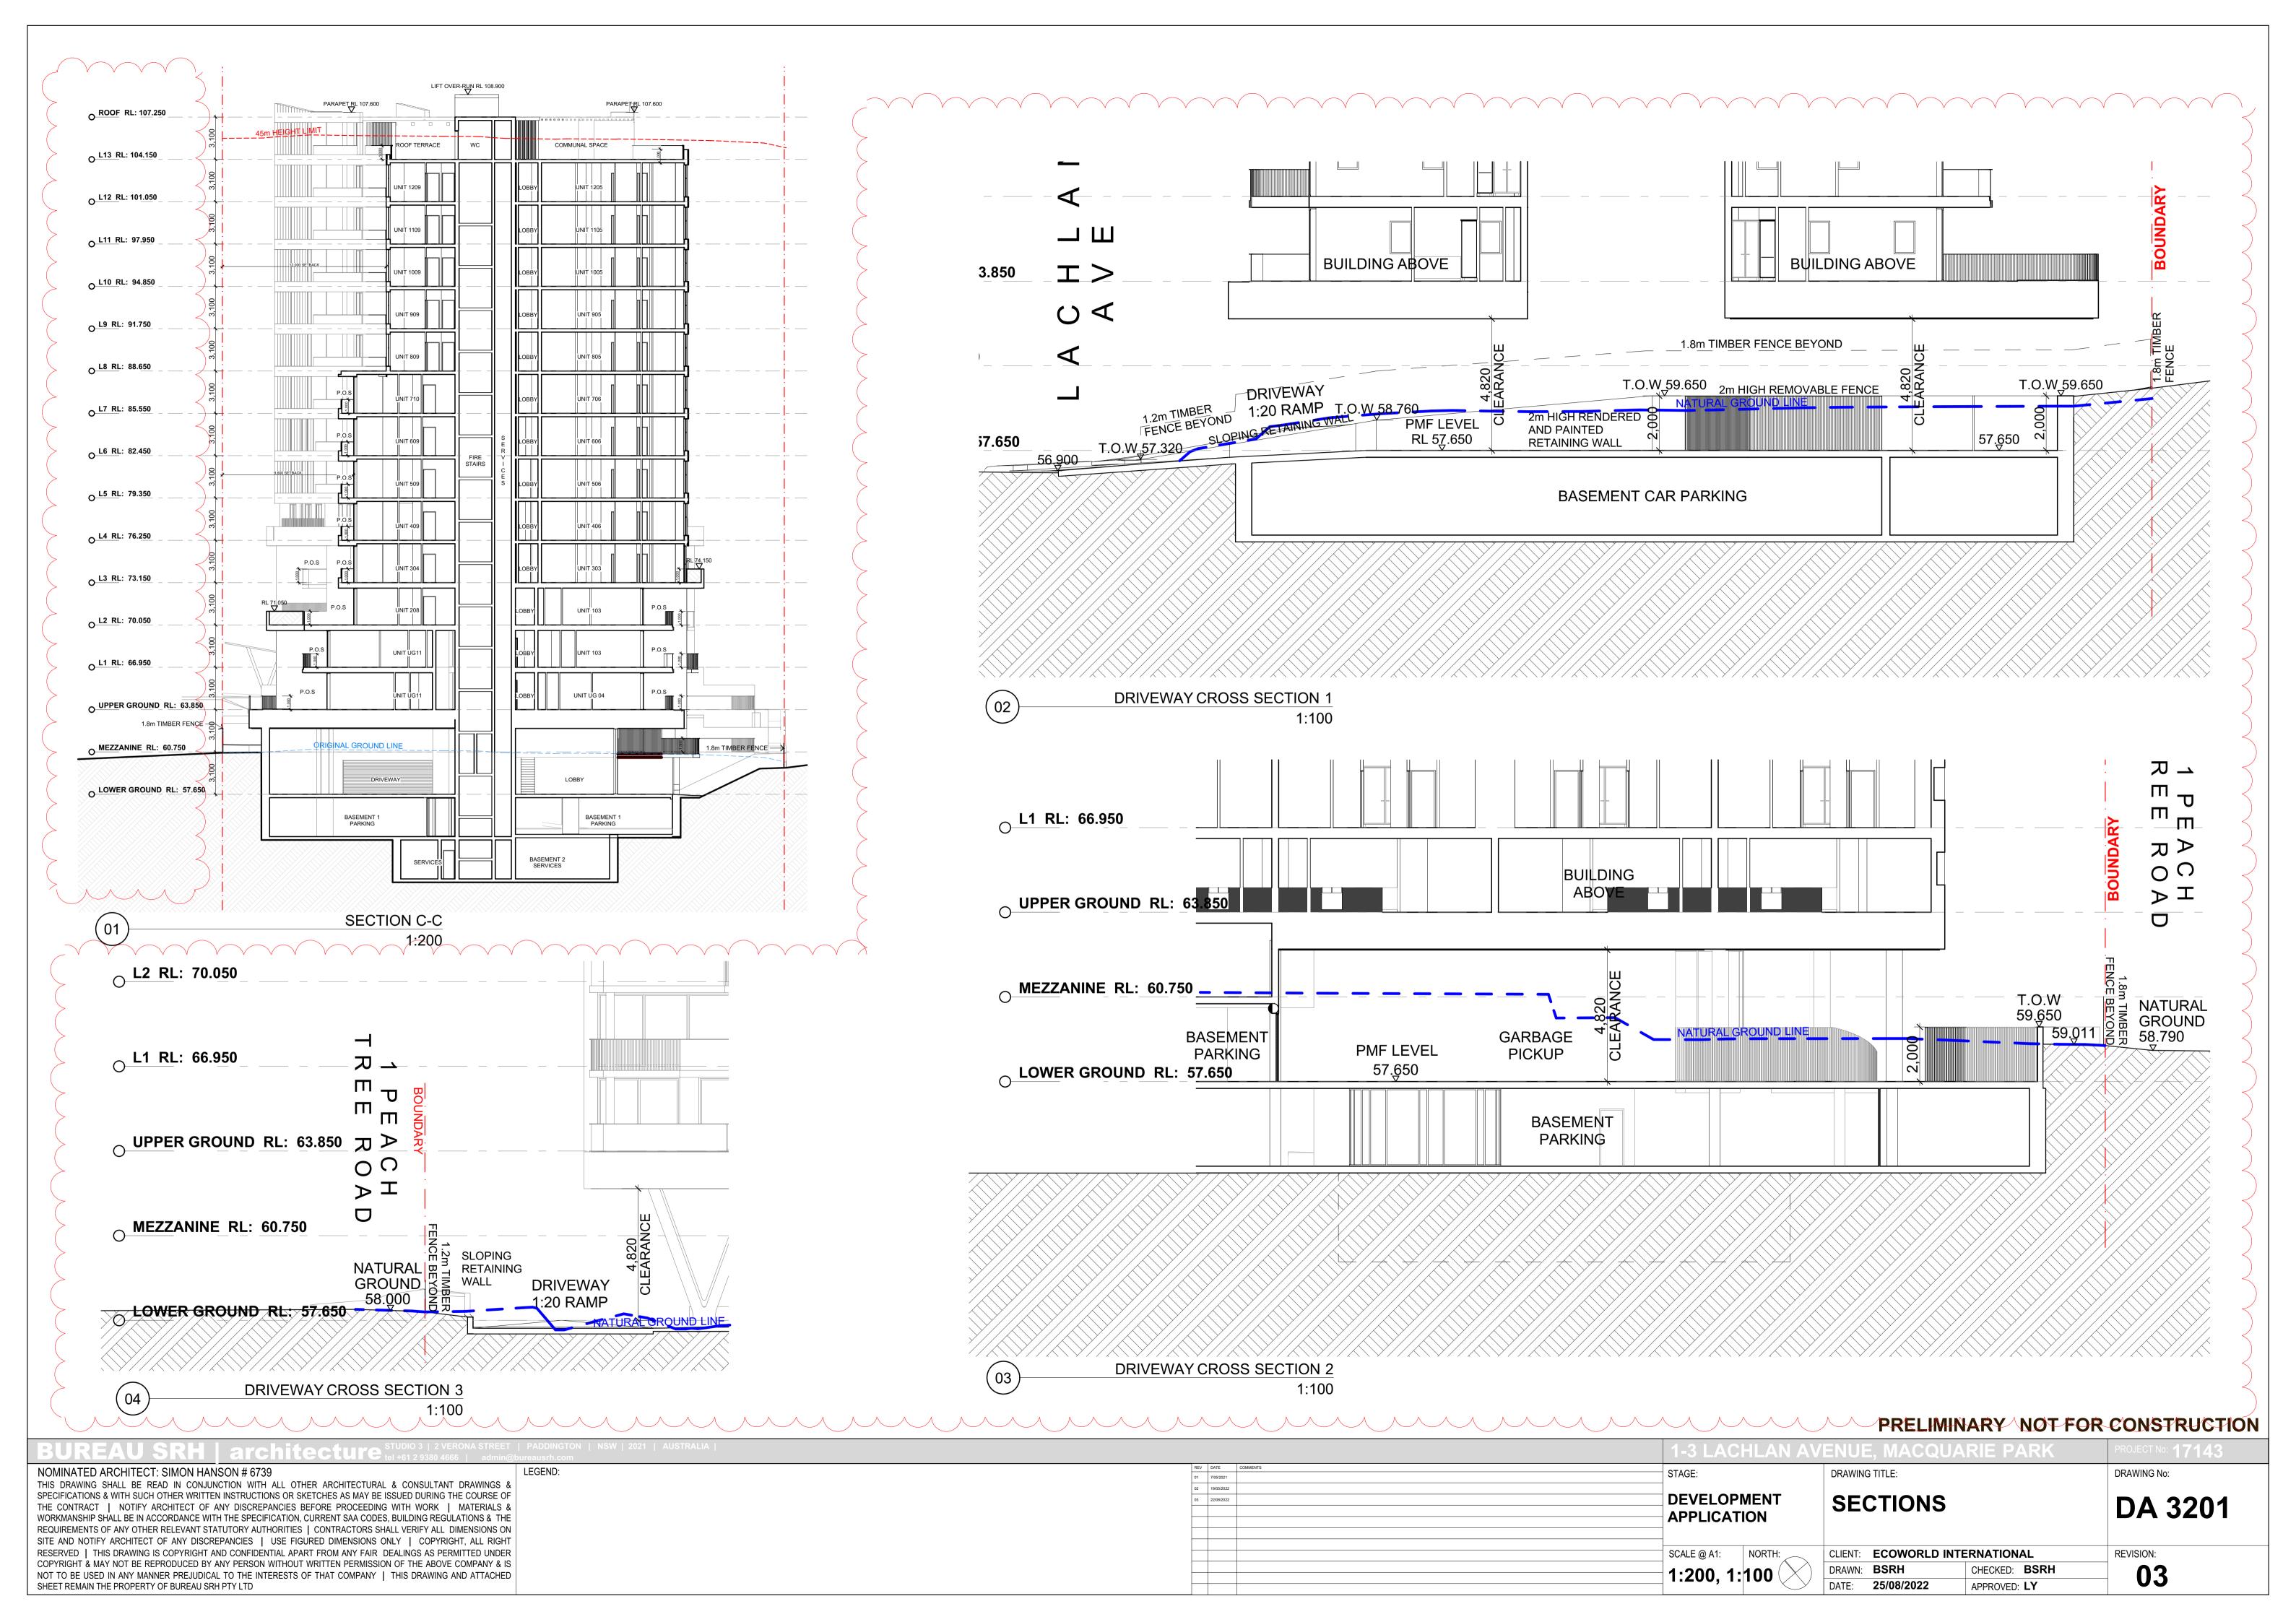
1-3 LACHLAN AVENUE, MACQUARIE PARK DRAWING TITLE: **WEST**

CT No: **17143** DRAWING No: **ELEVATIONS - SOUTH & DA 3101** REVISION:

CLIENT: **ECOWORLD INTERNATIONAL** S - TIMBER LOOKING SOFFIT DRAWN: **BSRH** CHECKED: **BSRH** 03 1:200 DATE: **25/08/2022** APPROVED: LY



BUREAU SRH architecture STUDIO 3 2 VERONA STREET			1-3 LACHLAN A	VENUE, MACQUARIE PARK	PROJECT No: 17143
NOMINATED ARCHITECT: SIMON HANSON # 6739	LEGEND:	REV DATE COMMENTS 01 7/05/2021	STAGE:	DRAWING TITLE:	DRAWING No:
THIS DRAWING SHALL BE READ IN CONJUNCTION WITH ALL OTHER ARCHITECTURAL & CONSULTANT DRAWINGS & SPECIFICATIONS & WITH SUCH OTHER WRITTEN INSTRUCTIONS OR SKETCHES AS MAY BE ISSUED DURING THE COURSE OF		02 19/05/2022	DEVEL ODMENT		
THE CONTRACT NOTIFY ARCHITECT OF ANY DISCREPANCIES BEFORE PROCEEDING WITH WORK MATERIALS &		03 22/08/2022	DEVELOPMENT	SECTIONS	DA 3200
WORKMANSHIP SHALL BE IN ACCORDANCE WITH THE SPECIFICATION, CURRENT SAA CODES, BUILDING REGULATIONS & THE REQUIREMENTS OF ANY OTHER RELEVANT STATUTORY AUTHORITIES CONTRACTORS SHALL VERIFY ALL DIMENSIONS OF			APPLICATION		271323
SITE AND NOTIFY ARCHITECT OF ANY DISCREPANCIES USE FIGURED DIMENSIONS ONLY COPYRIGHT, ALL RIGHT	нт				
RESERVED THIS DRAWING IS COPYRIGHT AND CONFIDENTIAL APART FROM ANY FAIR DEALINGS AS PERMITTED UNDER COPYRIGHT & MAY NOT BE REPRODUCED BY ANY PERSON WITHOUT WRITTEN PERMISSION OF THE ABOVE COMPANY & IS			SCALE @ A1: NORTH:	CLIENT: ECOWORLD INTERNATIONAL	REVISION:
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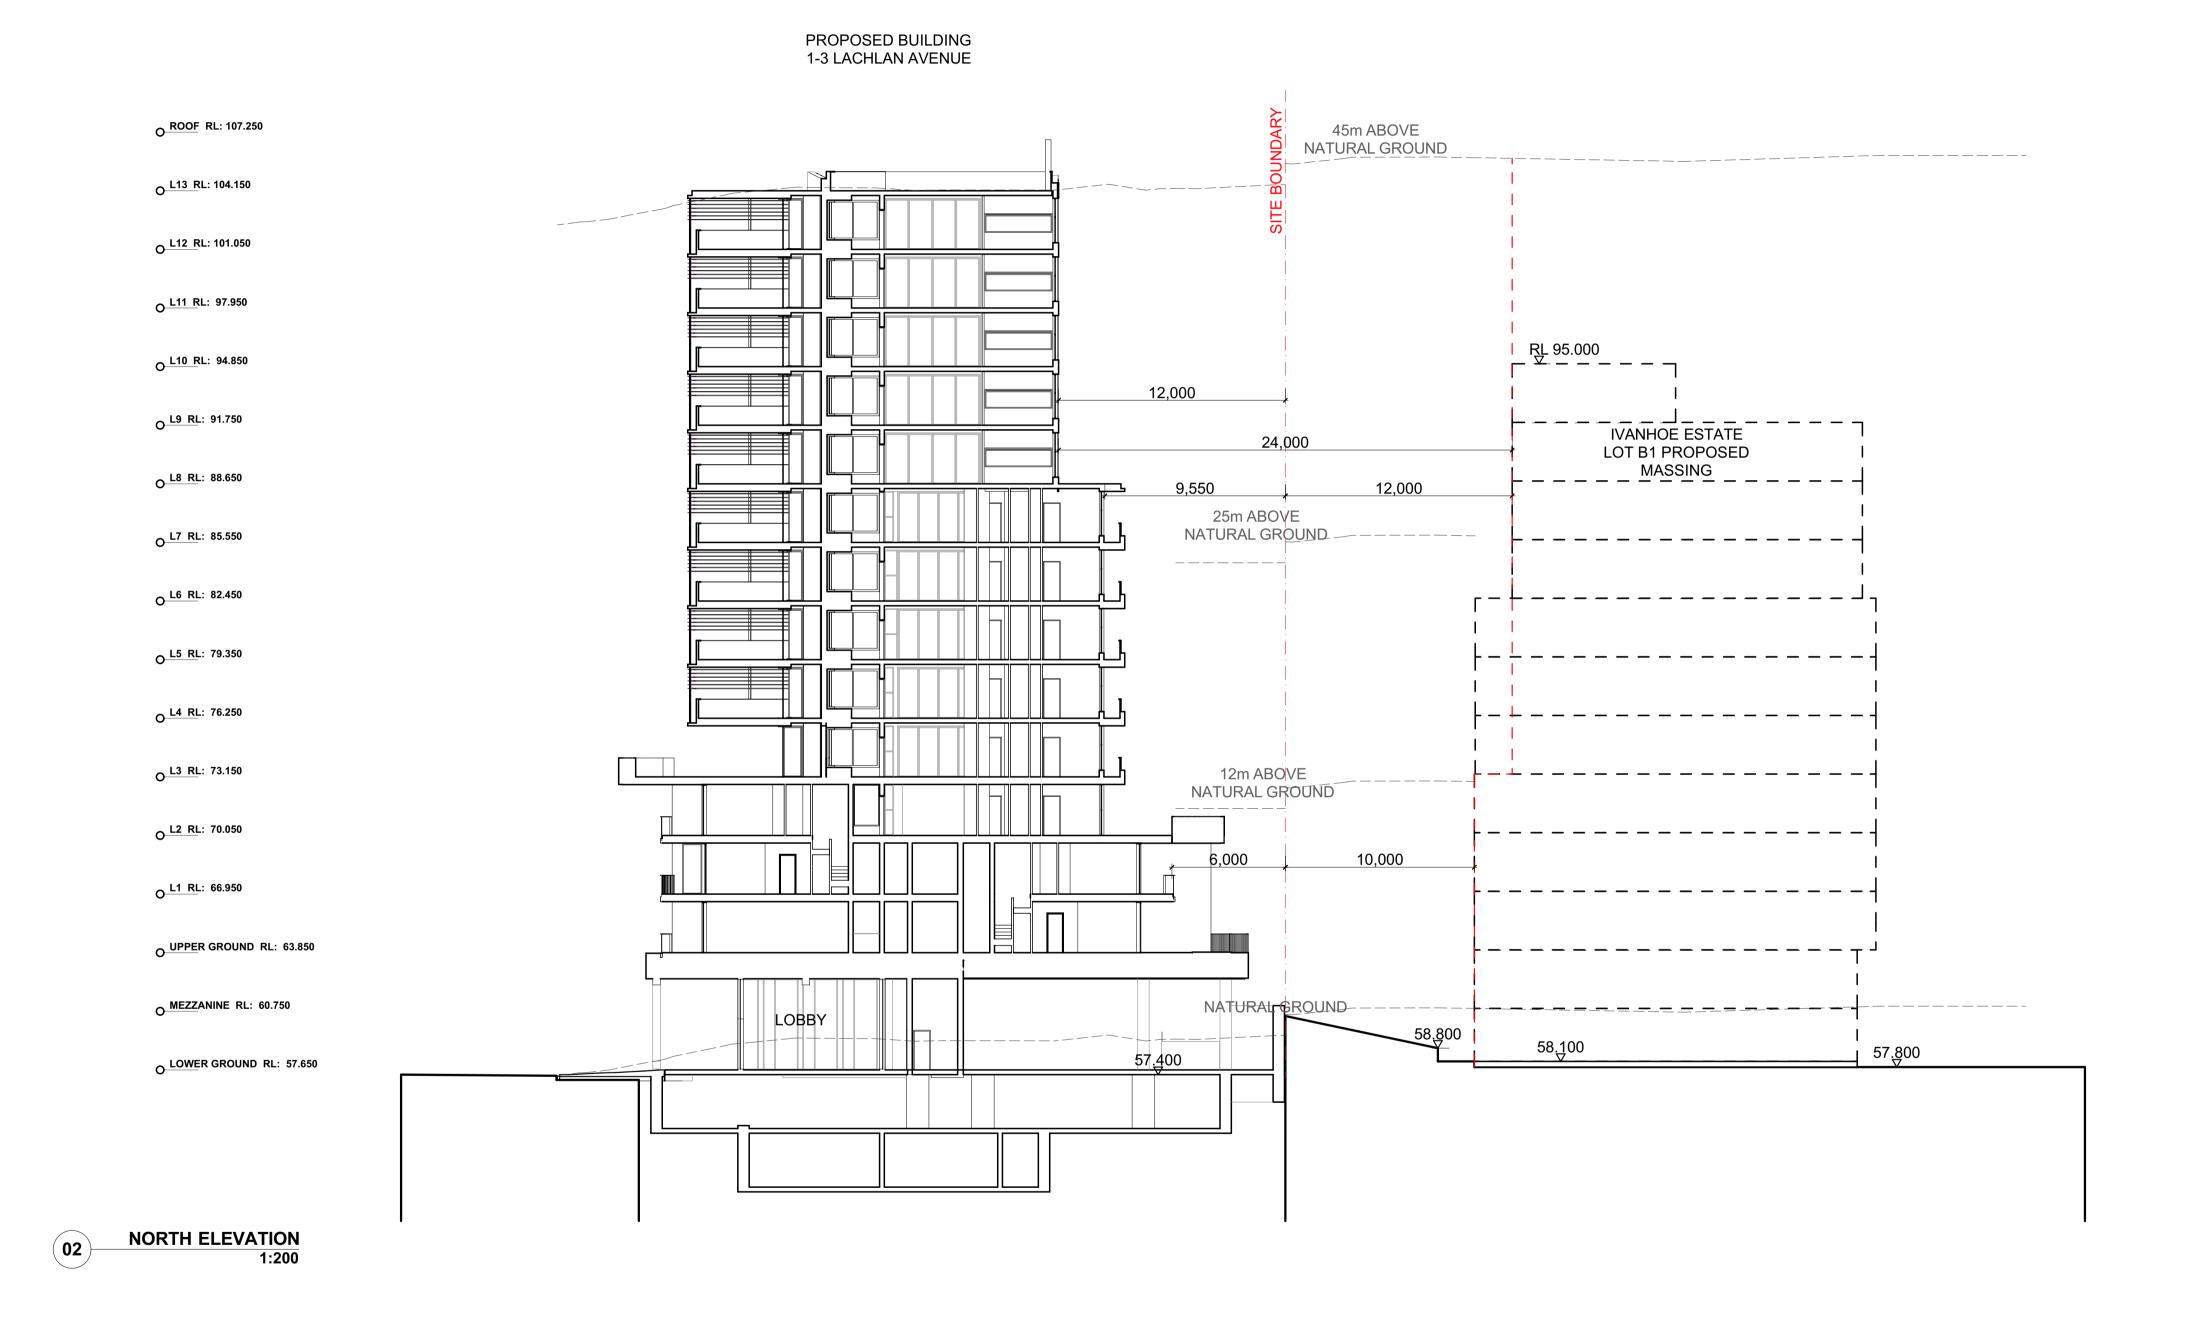


Table 1 Minimum building separation increases proportionally to the building height

Building height	Separation distance
9 storeys and above	12-24m
Up to 8 storeys	9-18m
Up to 4 storeys	6-12m

Minimum separation distances for buildings are:

Up to four storeys (approximately 12m):

- 12m between habitable rooms/balconies
- · 9m between habitable and non-habitable rooms
- · 6m between non-habitable rooms

Five to eight storeys (approximately 25m):

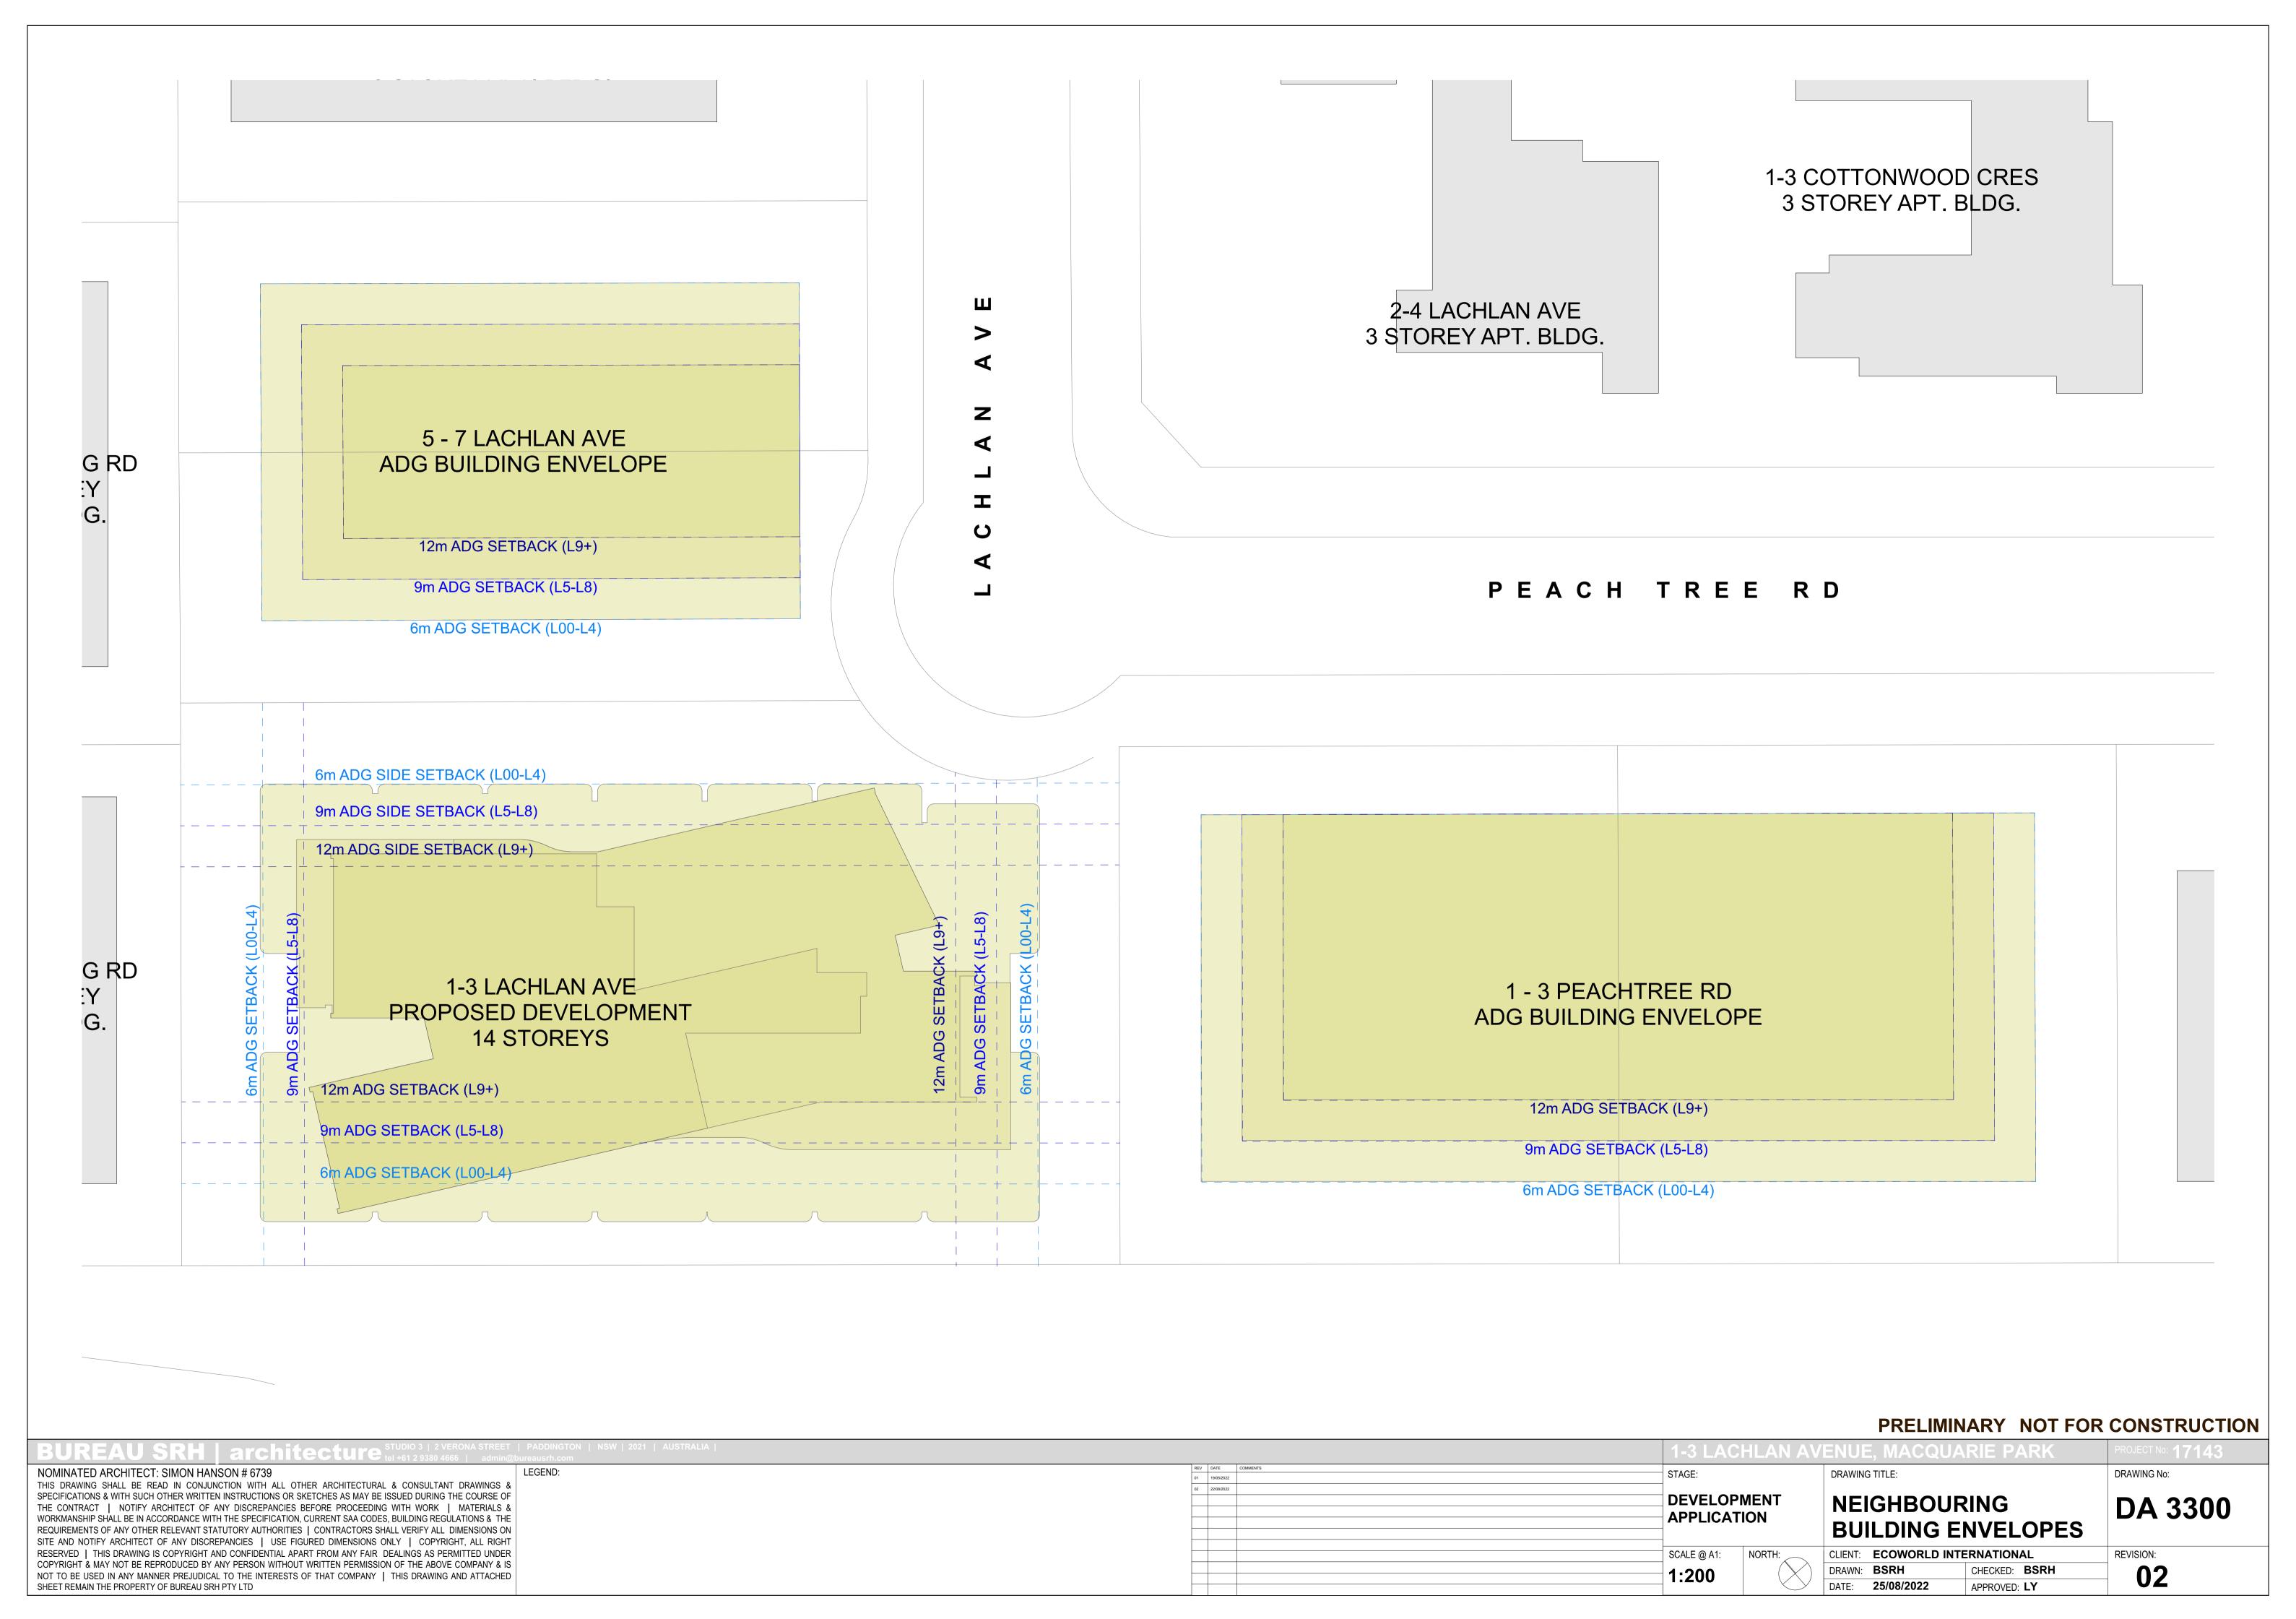
- 18m between habitable rooms/balconies
- 12m between habitable and non-habitable rooms
- · 9m between non-habitable rooms

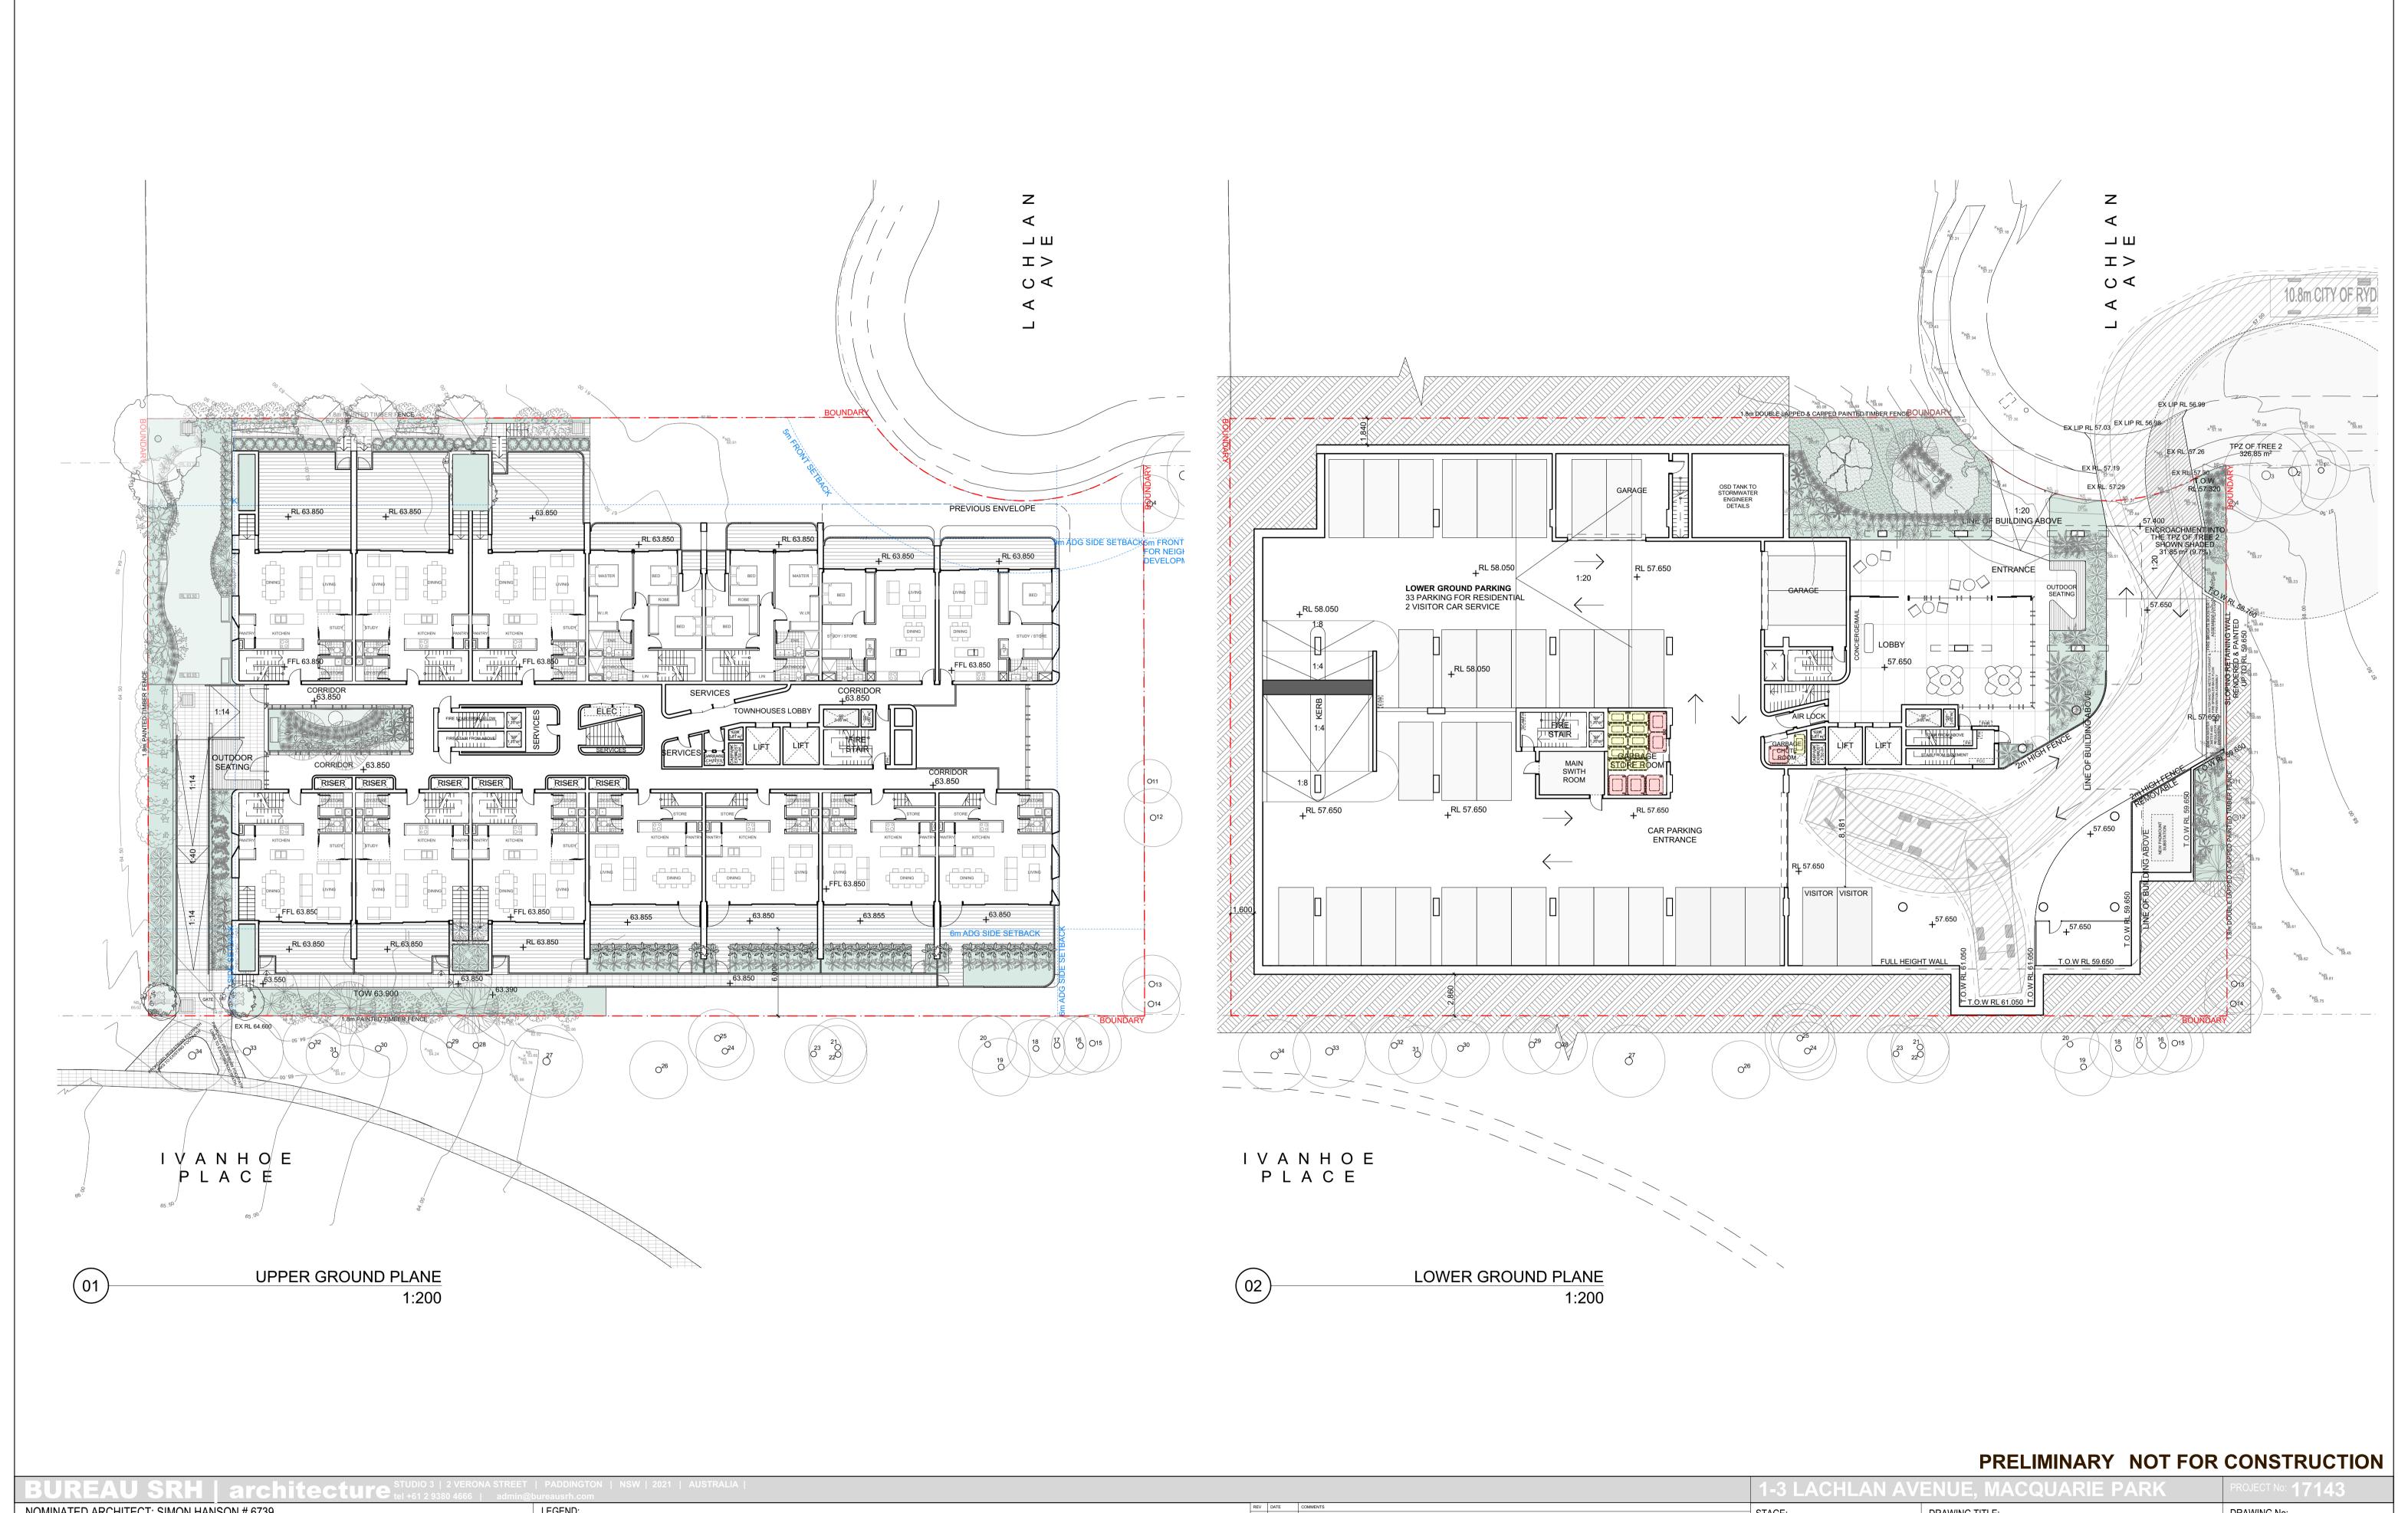
Nine storeys and above (over 25m):

- · 24m between habitable rooms/balconies
- 18m between habitable and non-habitable rooms
- 12m between non-habitable rooms

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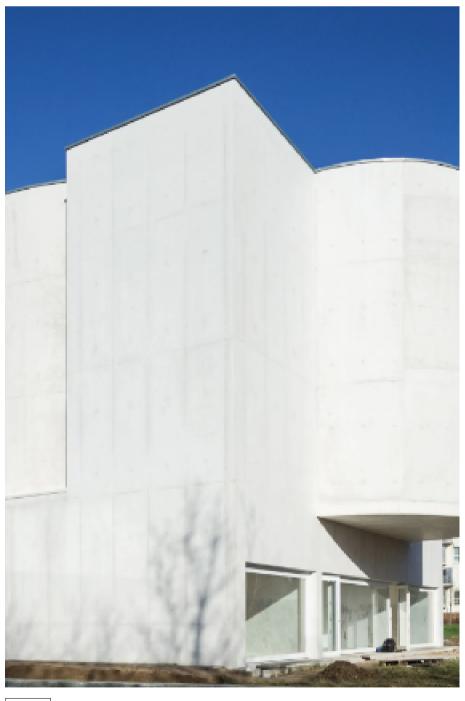
The podium pre-cast panels to all elevations shall have a deep panel profile with a panel thickness of approximately 300mm to achieve the splayed window reveals as shown on the east and west podium elevations.







PC02 - PRECAST CONCRETE FACADE
- MINERAL STAIN PAINT - DARK GREY
COLOUR OR SIMILAR



PC03 - PRECAST CONCRETE FACADE
- MINERAL STAIN PAINT - WHITE COLOUR OR
SIMILAR (FOR TOWER)



- FIXED HORIZONTAL SCREEN - FOR TOWER



GB - GLASS BALUSTRADE



TB - TIMBER LOOKING BALUSTRADE
- FOR PODIUM
- PRELIMINARY NOT FOR CONSTRUCTION

COLOUR OR SIMILAR (FOR PODIUM) COLOUR OR SIMILAR SIMILAR (FOR TOWER) 1 2 1 A CHI AN A VENUE MA COLIA DIE DA DK PROJECT NO: 4 74 42

BUREAU SRH architecture studio 3 2 VERONA STREET	T PADDINGTON NSW 2021 AUSTRALIA @bureausrh.com		1-3 LACHLAN A	VENUE, MACQUARIE PARK	PROJECT No: 17143
NOMINATED ARCHITECT: SIMON HANSON # 6739	LEGEND:	REV DATE COMMENTS 01 7/05/2021	STAGE:	DRAWING TITLE:	DRAWING No:
THIS DRAWING SHALL BE READ IN CONJUNCTION WITH ALL OTHER ARCHITECTURAL & CONSULTANT DRAWINGS		02 19/05/2022			
SPECIFICATIONS & WITH SUCH OTHER WRITTEN INSTRUCTIONS OR SKETCHES AS MAY BE ISSUED DURING THE COURSE O		03 22/08/2022	DEVELOPMENT	MATERIAL SCHEDULE	
THE CONTRACT NOTIFY ARCHITECT OF ANY DISCREPANCIES BEFORE PROCEEDING WITH WORK MATERIALS				MATERIAL SCHEDULE	DA 6000
WORKMANSHIP SHALL BE IN ACCORDANCE WITH THE SPECIFICATION, CURRENT SAA CODES, BUILDING REGULATIONS & TH			APPLICATION		
REQUIREMENTS OF ANY OTHER RELEVANT STATUTORY AUTHORITIES CONTRACTORS SHALL VERIFY ALL DIMENSIONS OF					
SITE AND NOTIFY ARCHITECT OF ANY DISCREPANCIES USE FIGURED DIMENSIONS ONLY COPYRIGHT, ALL RIGH					
RESERVED THIS DRAWING IS COPYRIGHT AND CONFIDENTIAL APART FROM ANY FAIR DEALINGS AS PERMITTED UNDER			SCALE @ A1: NORTH:	CLIENT: ECOWORLD INTERNATIONAL	REVISION:
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FRONT VIEW FROM LACHLAN AVENUE



REAR VIEW FROM IVANHOE PLACE



VIEW FROM 1 PEACHTREE ROAD



VIEW FOR BUILDING ENTRANCE



3D COMPARISON





ORIGINAL DA SUBMISSION

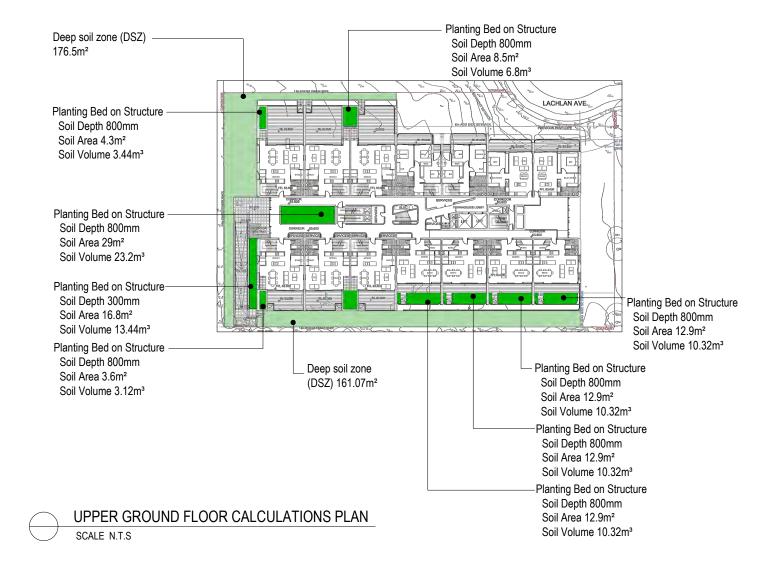
UPDATED FACADE DESIGN AND 3D IMAGE



LOWER GROUND FLOOR CALCULATIONS PLAN SCALE N.T.S

Deep soil zone (DSZ) 17.7m² Deep soil zone (DSZ) 74.8m² Deep soil zone (DSZ) 39.3m² SOUTH THE PLATION OF ON (F. 20)

LEGEND DEEP SOIL ZONE PLANTING ON STRUCTURE



2751.0m² Site Area Total Deep Soil Lower Ground Floor 147.9m² Total Deep Soil Mezzanine Floor 131.8m² Total Deep Soil Upper Ground Floor 337.6m²

Total Deep Soil 617.3m² (22.4%)

MEZZANINE FLOOR CALCULATIONS PLAN SCALE N.T.S

NOTES:
Contractors to check and verify all dimensions and all levels on site prior to any works. Any discrepancies should be immediately referred to Space Landscape Designs.
 - All work to comply with B.C.A. Statutory Authorities and relevant Australian Standards. - Dimensions recognised over scaling. All measurements are in millimetres.

05/05/21 Preliminar 05/05/21 DA Issue 16/05/22 DA Issue 12/08/22 DA Issue 23/08/22 DA Issue

ACE LANDSCAPE DESIGNS Space Landscape Designs Pty Ltd ABN 60 799 663 674 ACN 139 316 251

info@spacedesigns.com.au P 02 9905 7870 F 02 9905 7657 Suite 138, 117 Old Pittwater Rd,

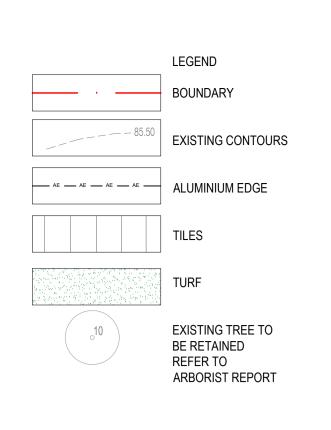
Proposed Residential Flat Building

1-3 Lachlan Avenue, Macquarie Park

CLIENT: Ecoworld International DRN: C.Wallace (B.LArch) SCALE: N.T.S @A3 PROJECT NO: 211854

LANDSCAPE DRAWING TITLE: **CALCULATIONS** DRAWING No:

L-08



	PROPO	SED PLANT SCHEDUL	Ε		
KEY	BOTANICAL NAME	COMMON NAME	QTY	MATURE HGT	POT SIZE
	TREES / PALMS				
CM	CORYMBIA MACULATA	SPOTTED GUM	1	15m	75Ltr
CA	CYATHEA AUSTRALIS	ROUGH TREE FERN	5	4m	300mm
CS	CHAMAEDOREA SEIFRIZII	BAMBOO PALM	7	3m	45Ltr
ER	ELAEOCARPUS RETICULATUS	BLUEBERRY ASH	2	8m	75Ltr
RE	RHAPIS EXCELSA	RHAPIS PALM	9	3m	45Ltr
TL	TRISTANIOPSIS LAURINA 'LUSCIOUS'	LUSCIOUS WATER GUM	1	8m	75Ltr
	SHRUBS				
AC	ALPINIA CAERULEA	NATIVE GINGER	5	2m	200mm
SP	SYZYGIUM PANICULATUM 'DWARF'	DWARF LILLY PILLY	5	3m	300mm
	GRASSES / GROUND COVERS				
AA	ASPLENIUM AUSTRALASICUM	BIRDS NEST FERN	13	1m	200mm
ΑI	ALCANTAREA IMPERIALIS 'RUBRA'	GIANT BROMELIAD	2	1.5m	200mm
BN	BLECHNUM NUDUM	FISHBONE WATERFERN	5	0.8m	200mm
DC	DIANELLA CAERULEA 'LITTLE JESS'	LITTLE JESS	60	0.4m	140mm
LN	LOMANDRA LONGIFOLIA 'NYALLA'	NYALLA	8	0.8m	140mm
PΧ	PHILODENDRON SELLOUM 'XANADU'	PHILODENDRON	35	1m	250mm
VH	VIOLA HEDERACEA	NATIVE VIOLET	15	0.1m	140mm

PLANTING PALETTE





CYATHEA AUSTRALIS



CHAMAEDOREA SEIFRIZII

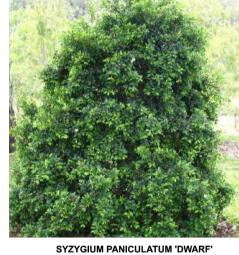




RHAPIS EXCELSA



ELAEOCARPUS RETICULATUS

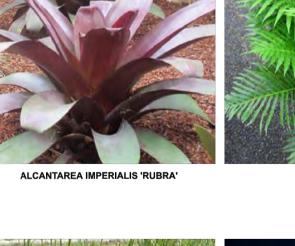














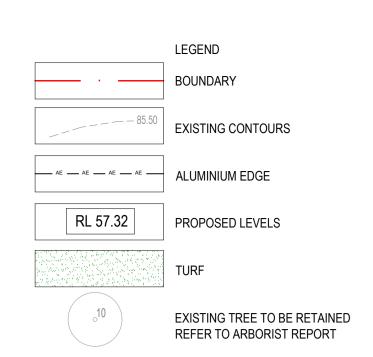








LOMANDRA LONGIFOLIA 'NYALLA'

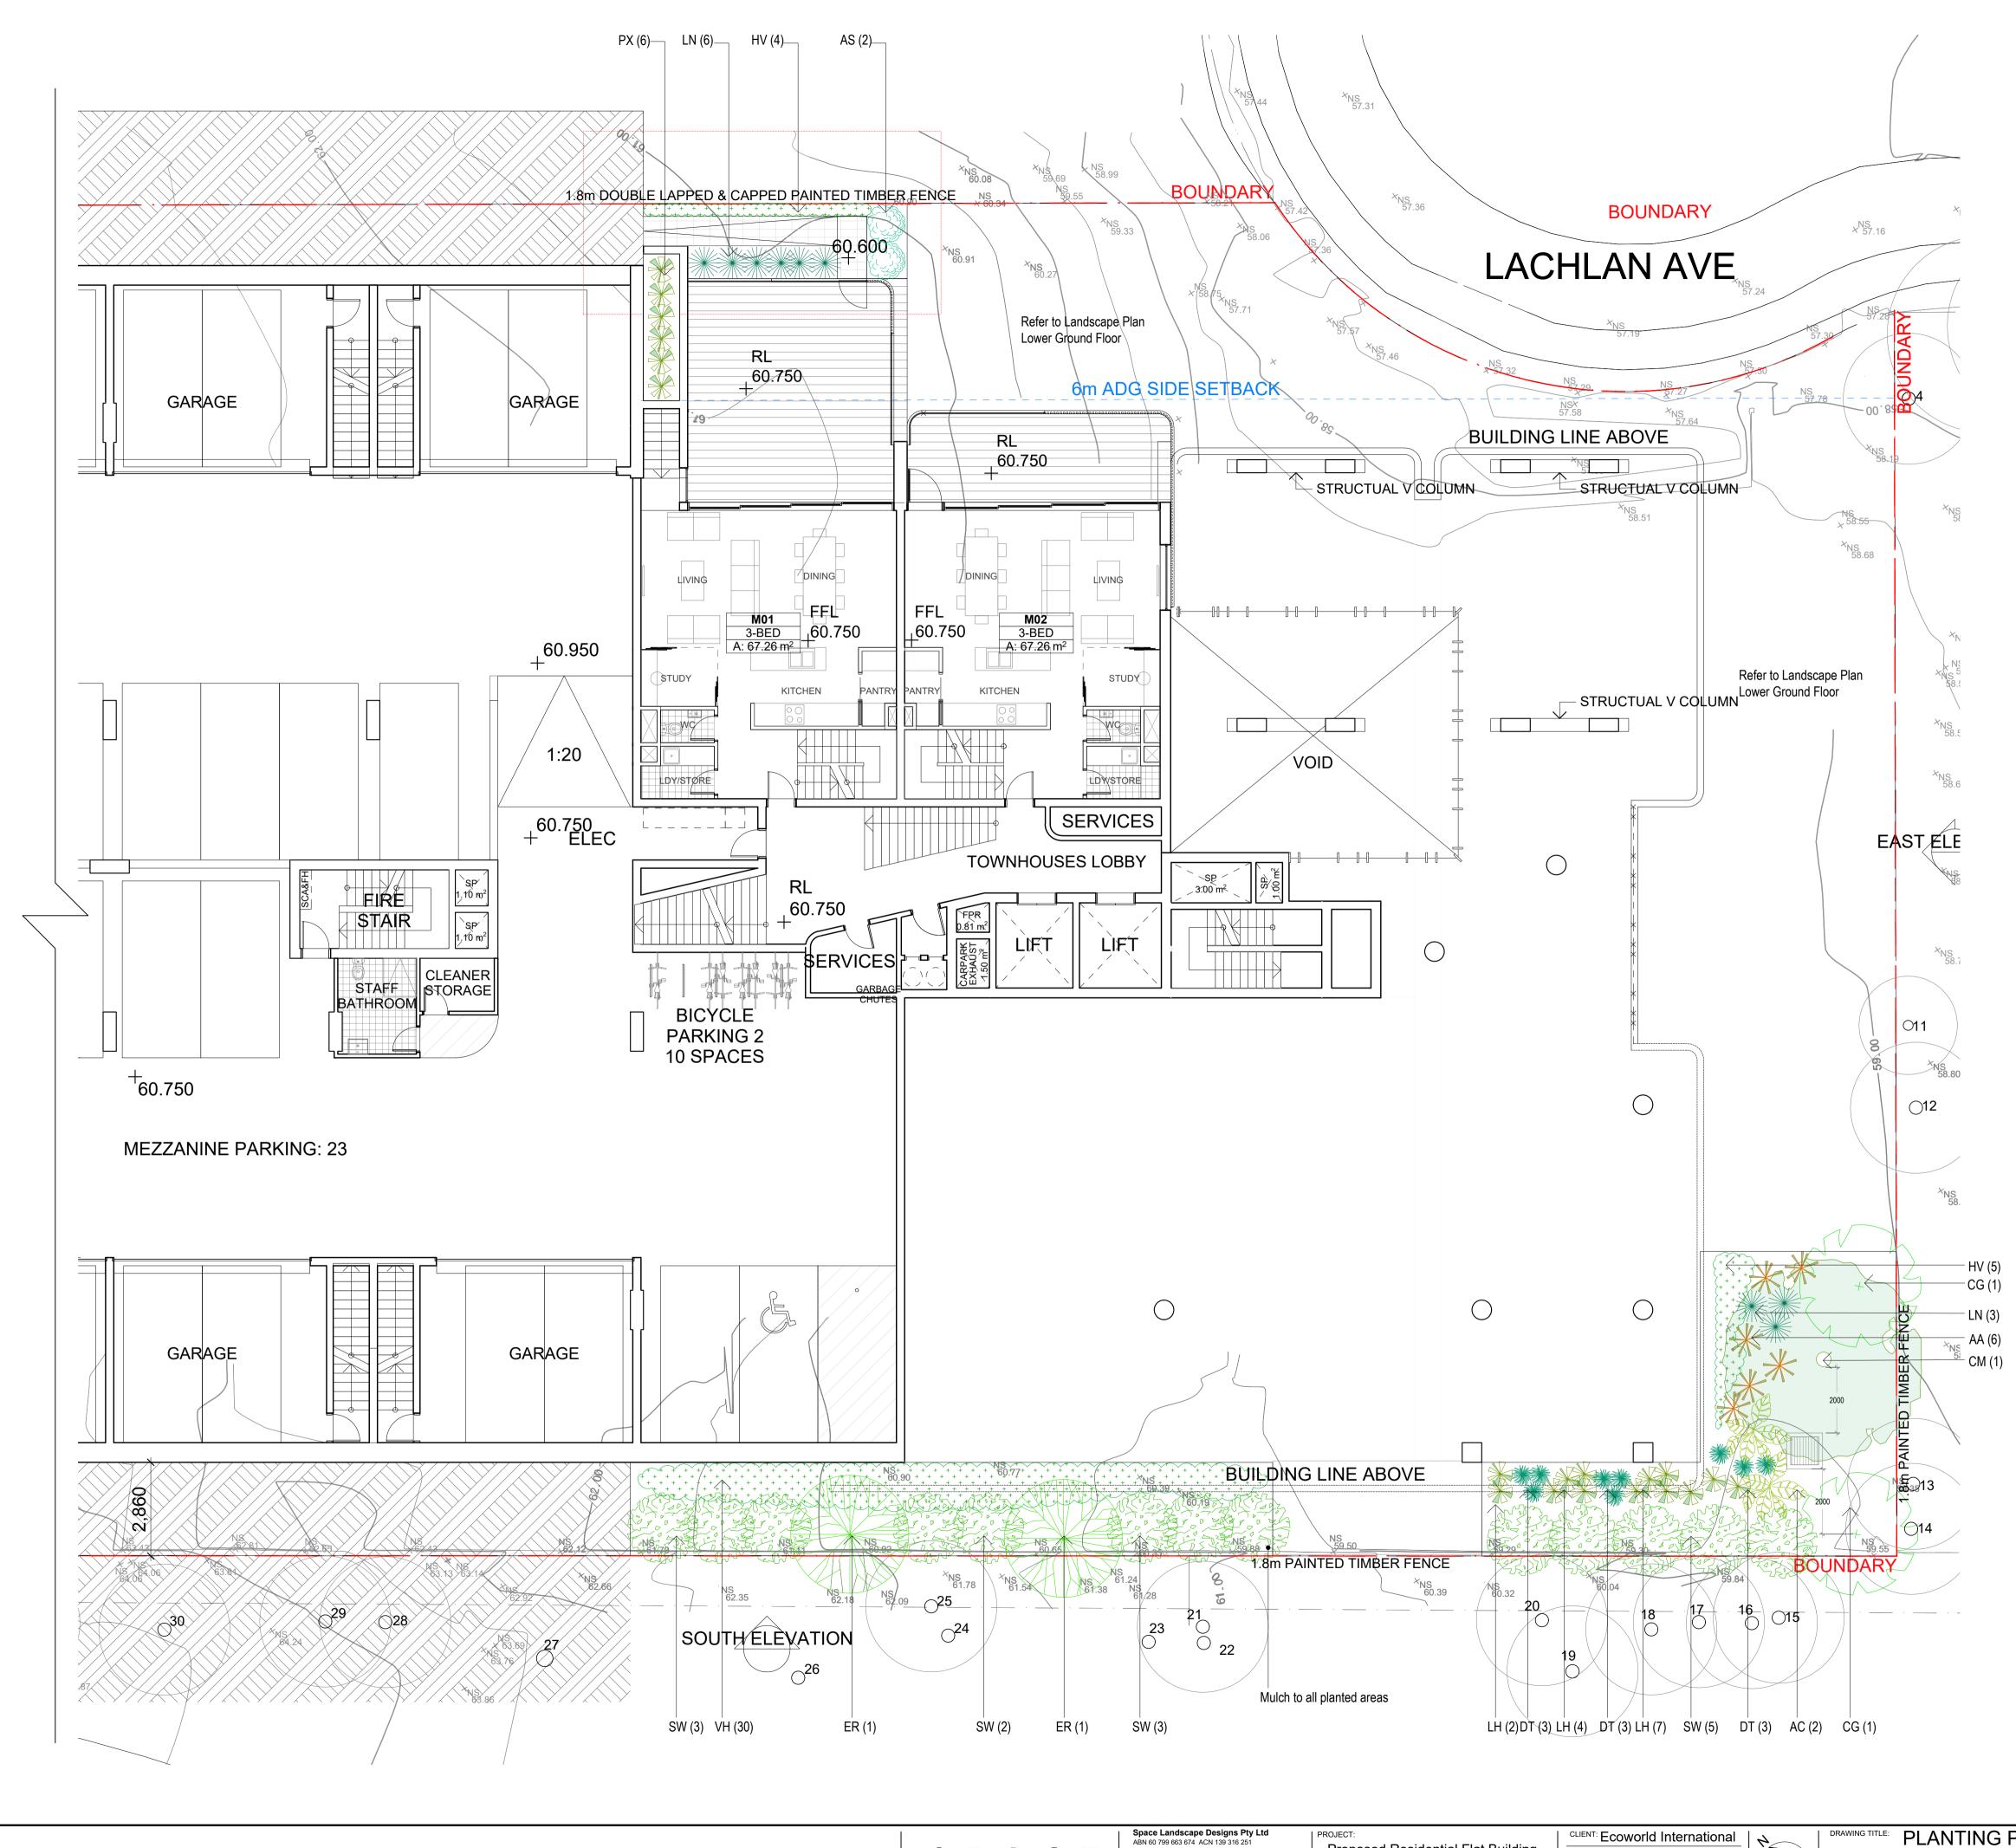


KEY	BOTANICAL NAME	COMMON NAME	QTY	MATURE HGT	POT SIZE
	TREES / PALMS				
CG	CERATOPETALUM GUMMIFERUM	NSW XMAS BUSH	2	6m	45Ltr
CM	CORYMBIA MACULATA	SPOTTED GUM	1	15m	75Ltr
ER	ELAEOCARPUS RETICULATUS	BLUEBERRY ASH	2	8m	45Ltr
	SHRUBS				
AC	ALPINIA CAERULEA	NATIVE GINGER	2	2m	200n
AS	ACMENA SMITHII 'CHERRY SURPRISE'	CHERRY SURPRISE	2	2.5m	200n
SW	SYZYGIUM WILSONII	POWDERPUFF LILLY PILLY	13	4m	300m
	GRASSES / GROUND COVERS				
AA	ASPLENIUM AUSTRALASICUM	BIRDS NEST FERN	6	1m	200r
DT	DIANELLA TASMANICA 'TASRED'	TASRED	9	0.4m	140n
HV	HARDENBERGIA VIOLACEA	PURPLE CORAL PEA	9	0.2m	140r
LH	LOMANDRA HYSTRIX 'TROPIC CASCADE'	TROPIC CASCADE	13	0.6m	140n
LN	LOMANDRA LONGIFOLIA 'NYALLA'	NYALLA	9	0.8m	140r
PΧ	PHILODENDRON SELLOUM 'XANADU'	PHILODENDRON	6	1m	250n
VH	VIOLA HEDERACEA	NATIVE VIOLET	30	0.1m	140n

PLANT PALETTE

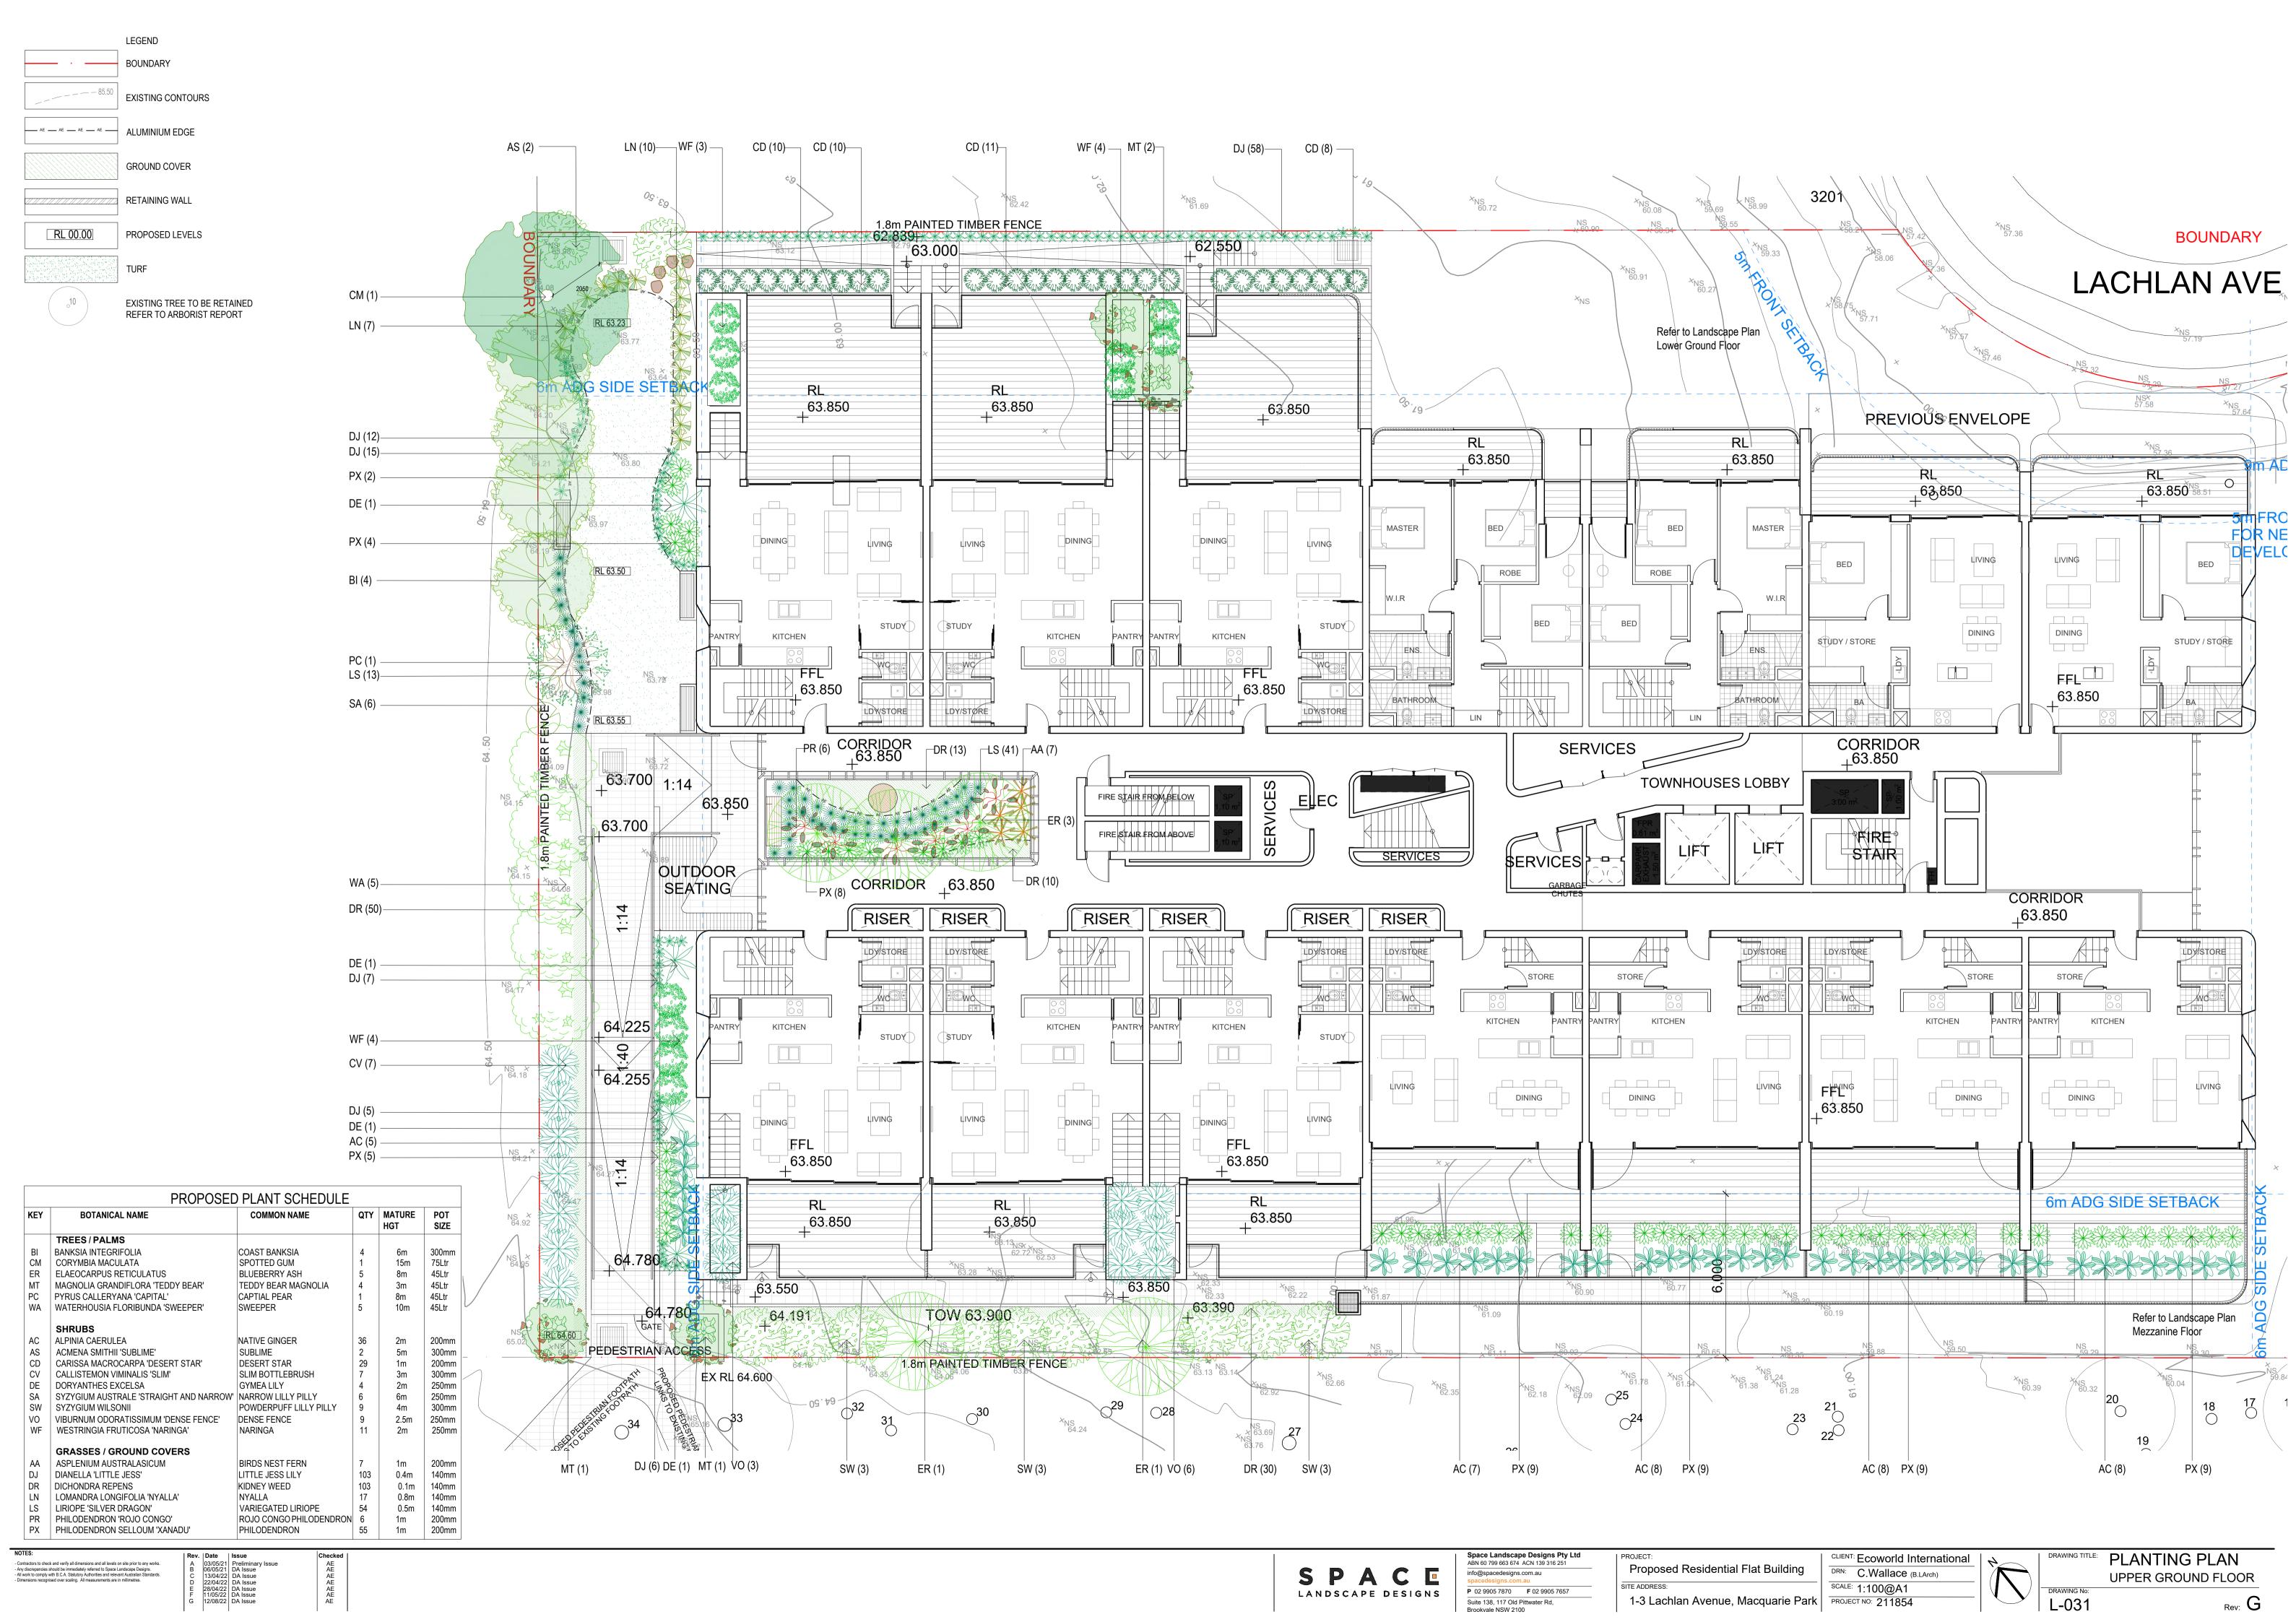


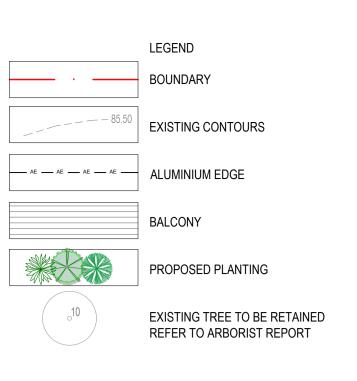




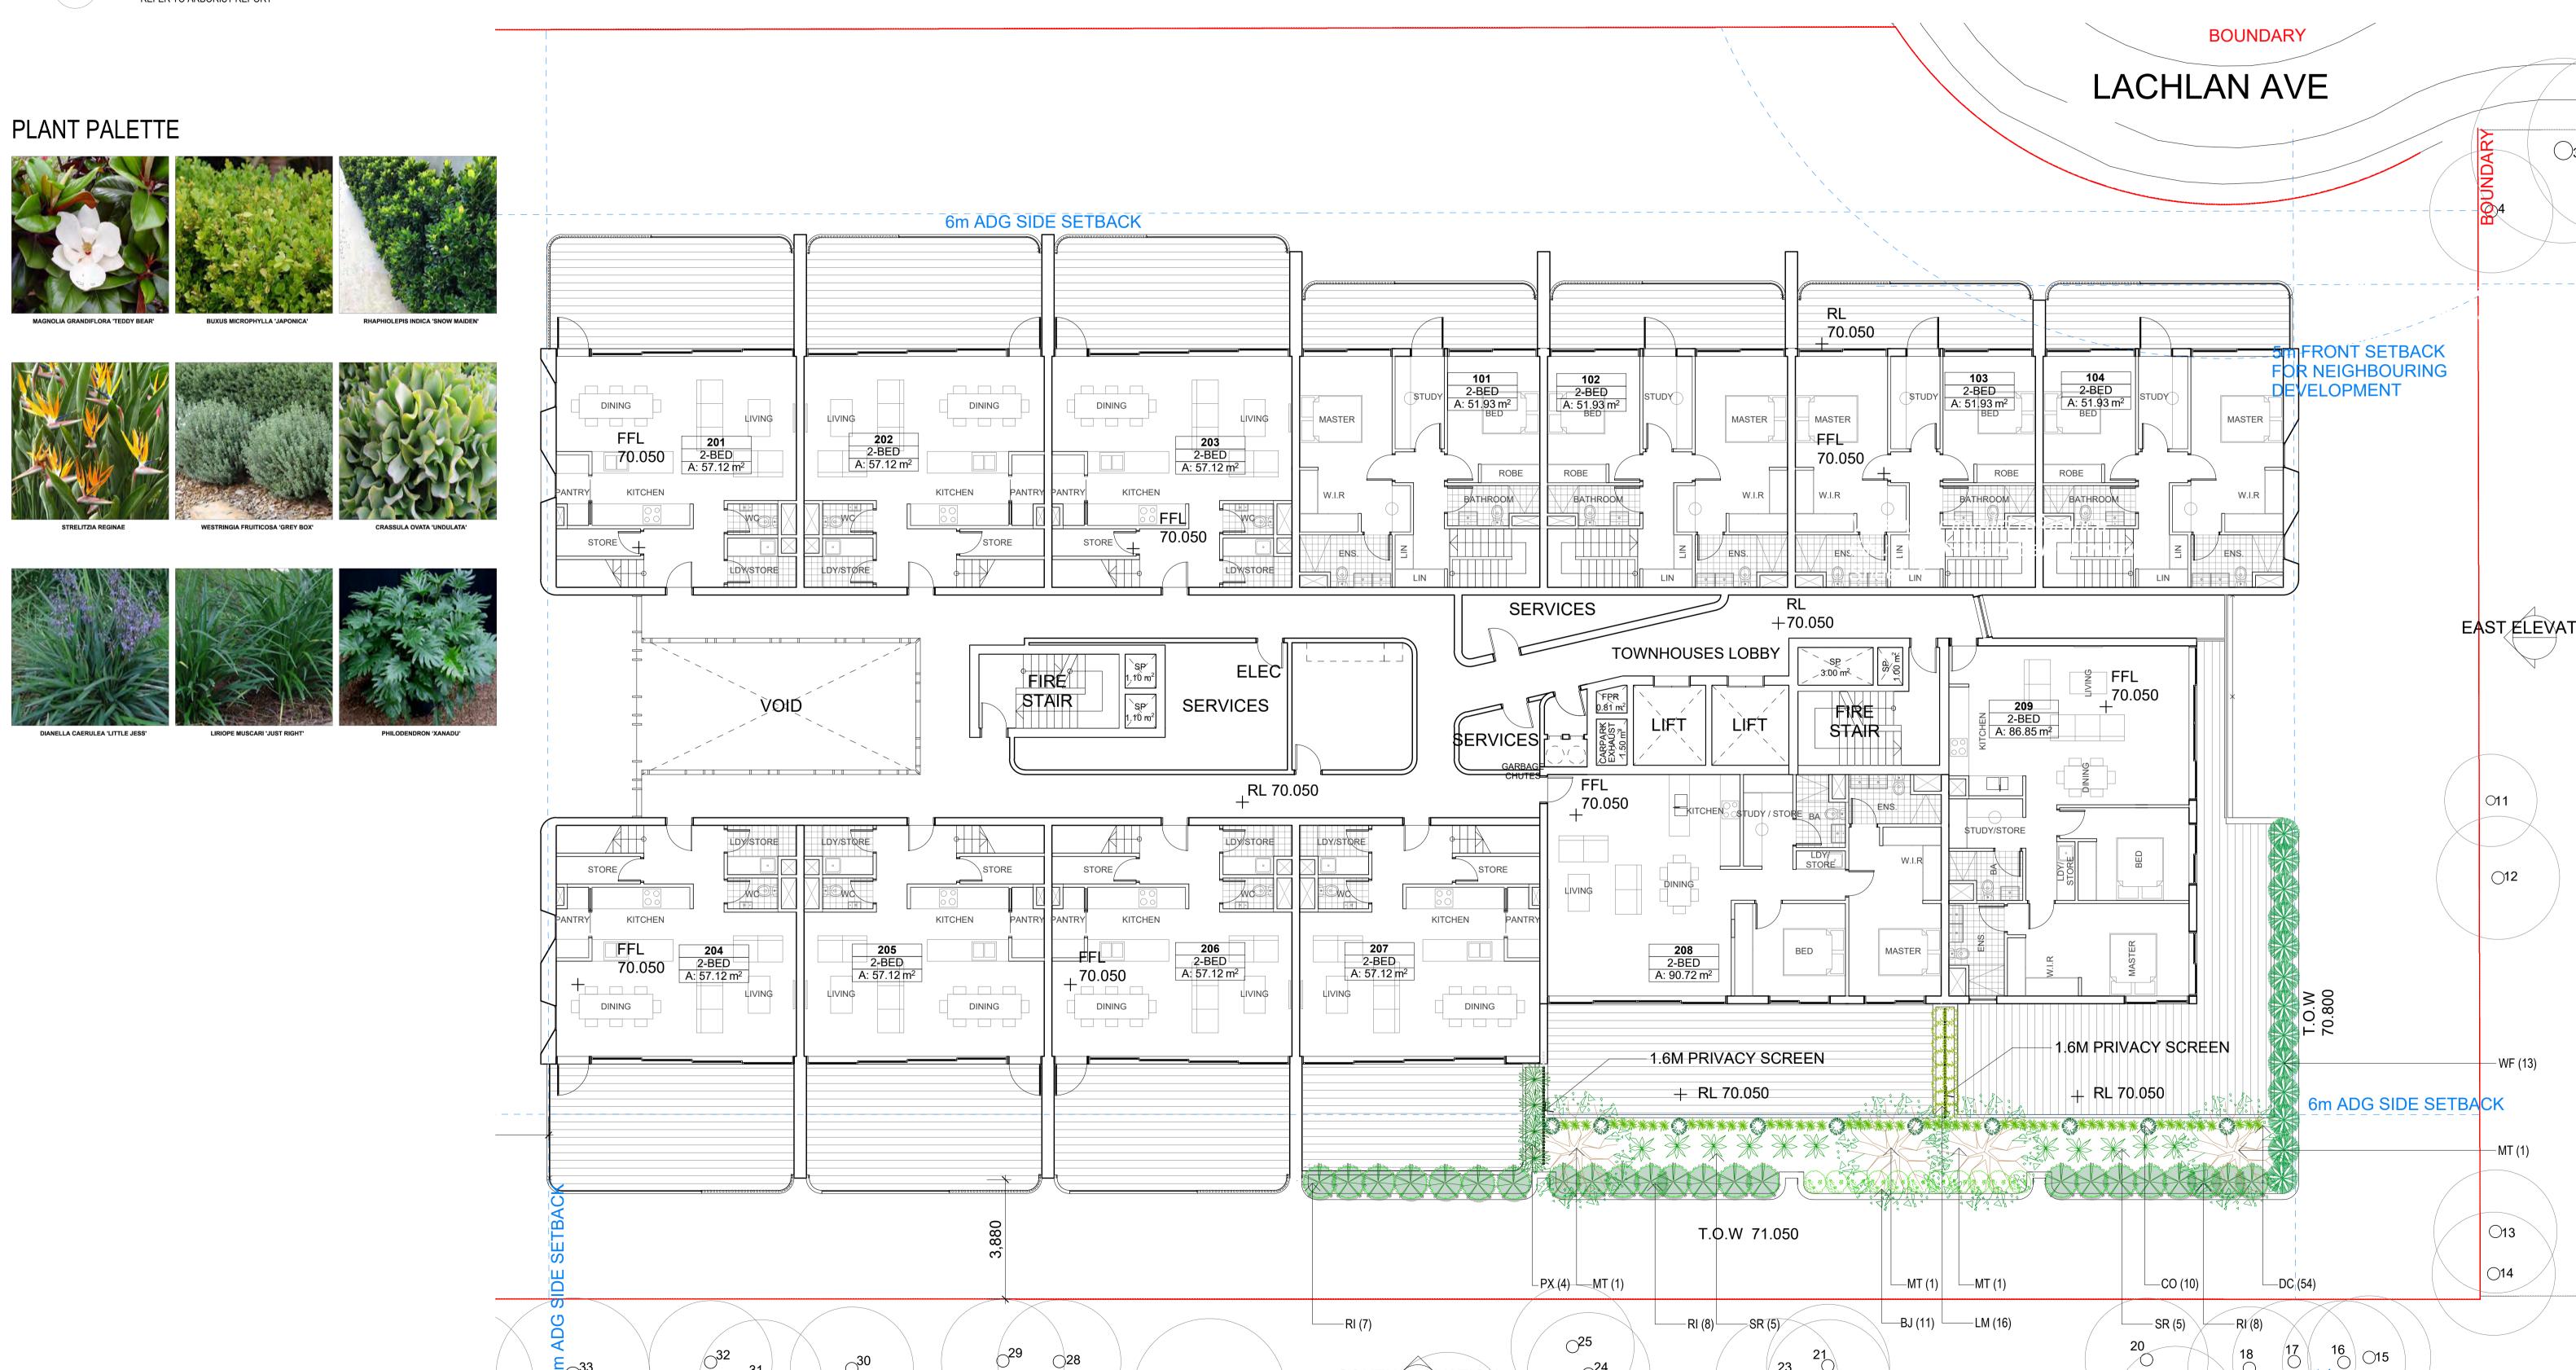
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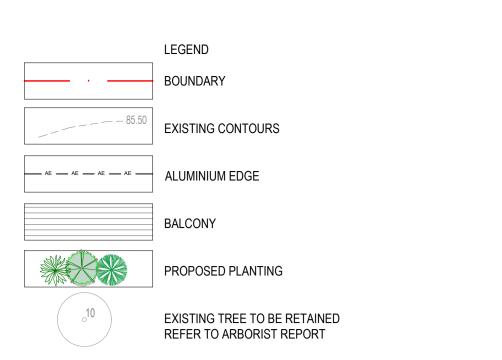


	PROPOS	ED PLANT SCHEDUL	E		
KEY	BOTANICAL NAME	COMMON NAME	QTY	MATURE HGT	POT SIZE
	TREES				
MT	MAGNOLIA GRANDIFLORA 'TEDDY BEAR'	TEDDY BEAR MAGNOLIA	4	3m	300mm
	SHRUBS				
BJ	BUXUS MICROPHYLLA 'JAPONICA'	JAPANESE BOX	11	1m	250mm
RI	RHAPHIOLEPIS INDICA 'SNOW MAIDEN'	SNOW MAIDEN	23	1m	250mm
SR	STRELITZIA REGINAE	BIRD OF PARADISE	10	1.2m	250mm
WF	WESTRINGIA FRUTICOSA 'GREY BOX'	GREY BOX WESTRINGIA	13	0.9m	250mm
	GRASSES / GROUND COVERS / SUCC	CULENTS			
CO	CRASSULA OVATA 'UNDULATA'	CRASSULA	10	0.5m	200mm
DC	DIANELLA CAERULEA 'LITTLE JESS'	LITTLE JESS	54	0.4m	200mm
LM	LIRIOPE MUSCARI 'JUST RIGHT'	JUST RIGHT	16	0.5m	200mm
PX	PHILODENDRON SELLOUM 'XANADU'	PHILODENDRON	4	1m	200mm



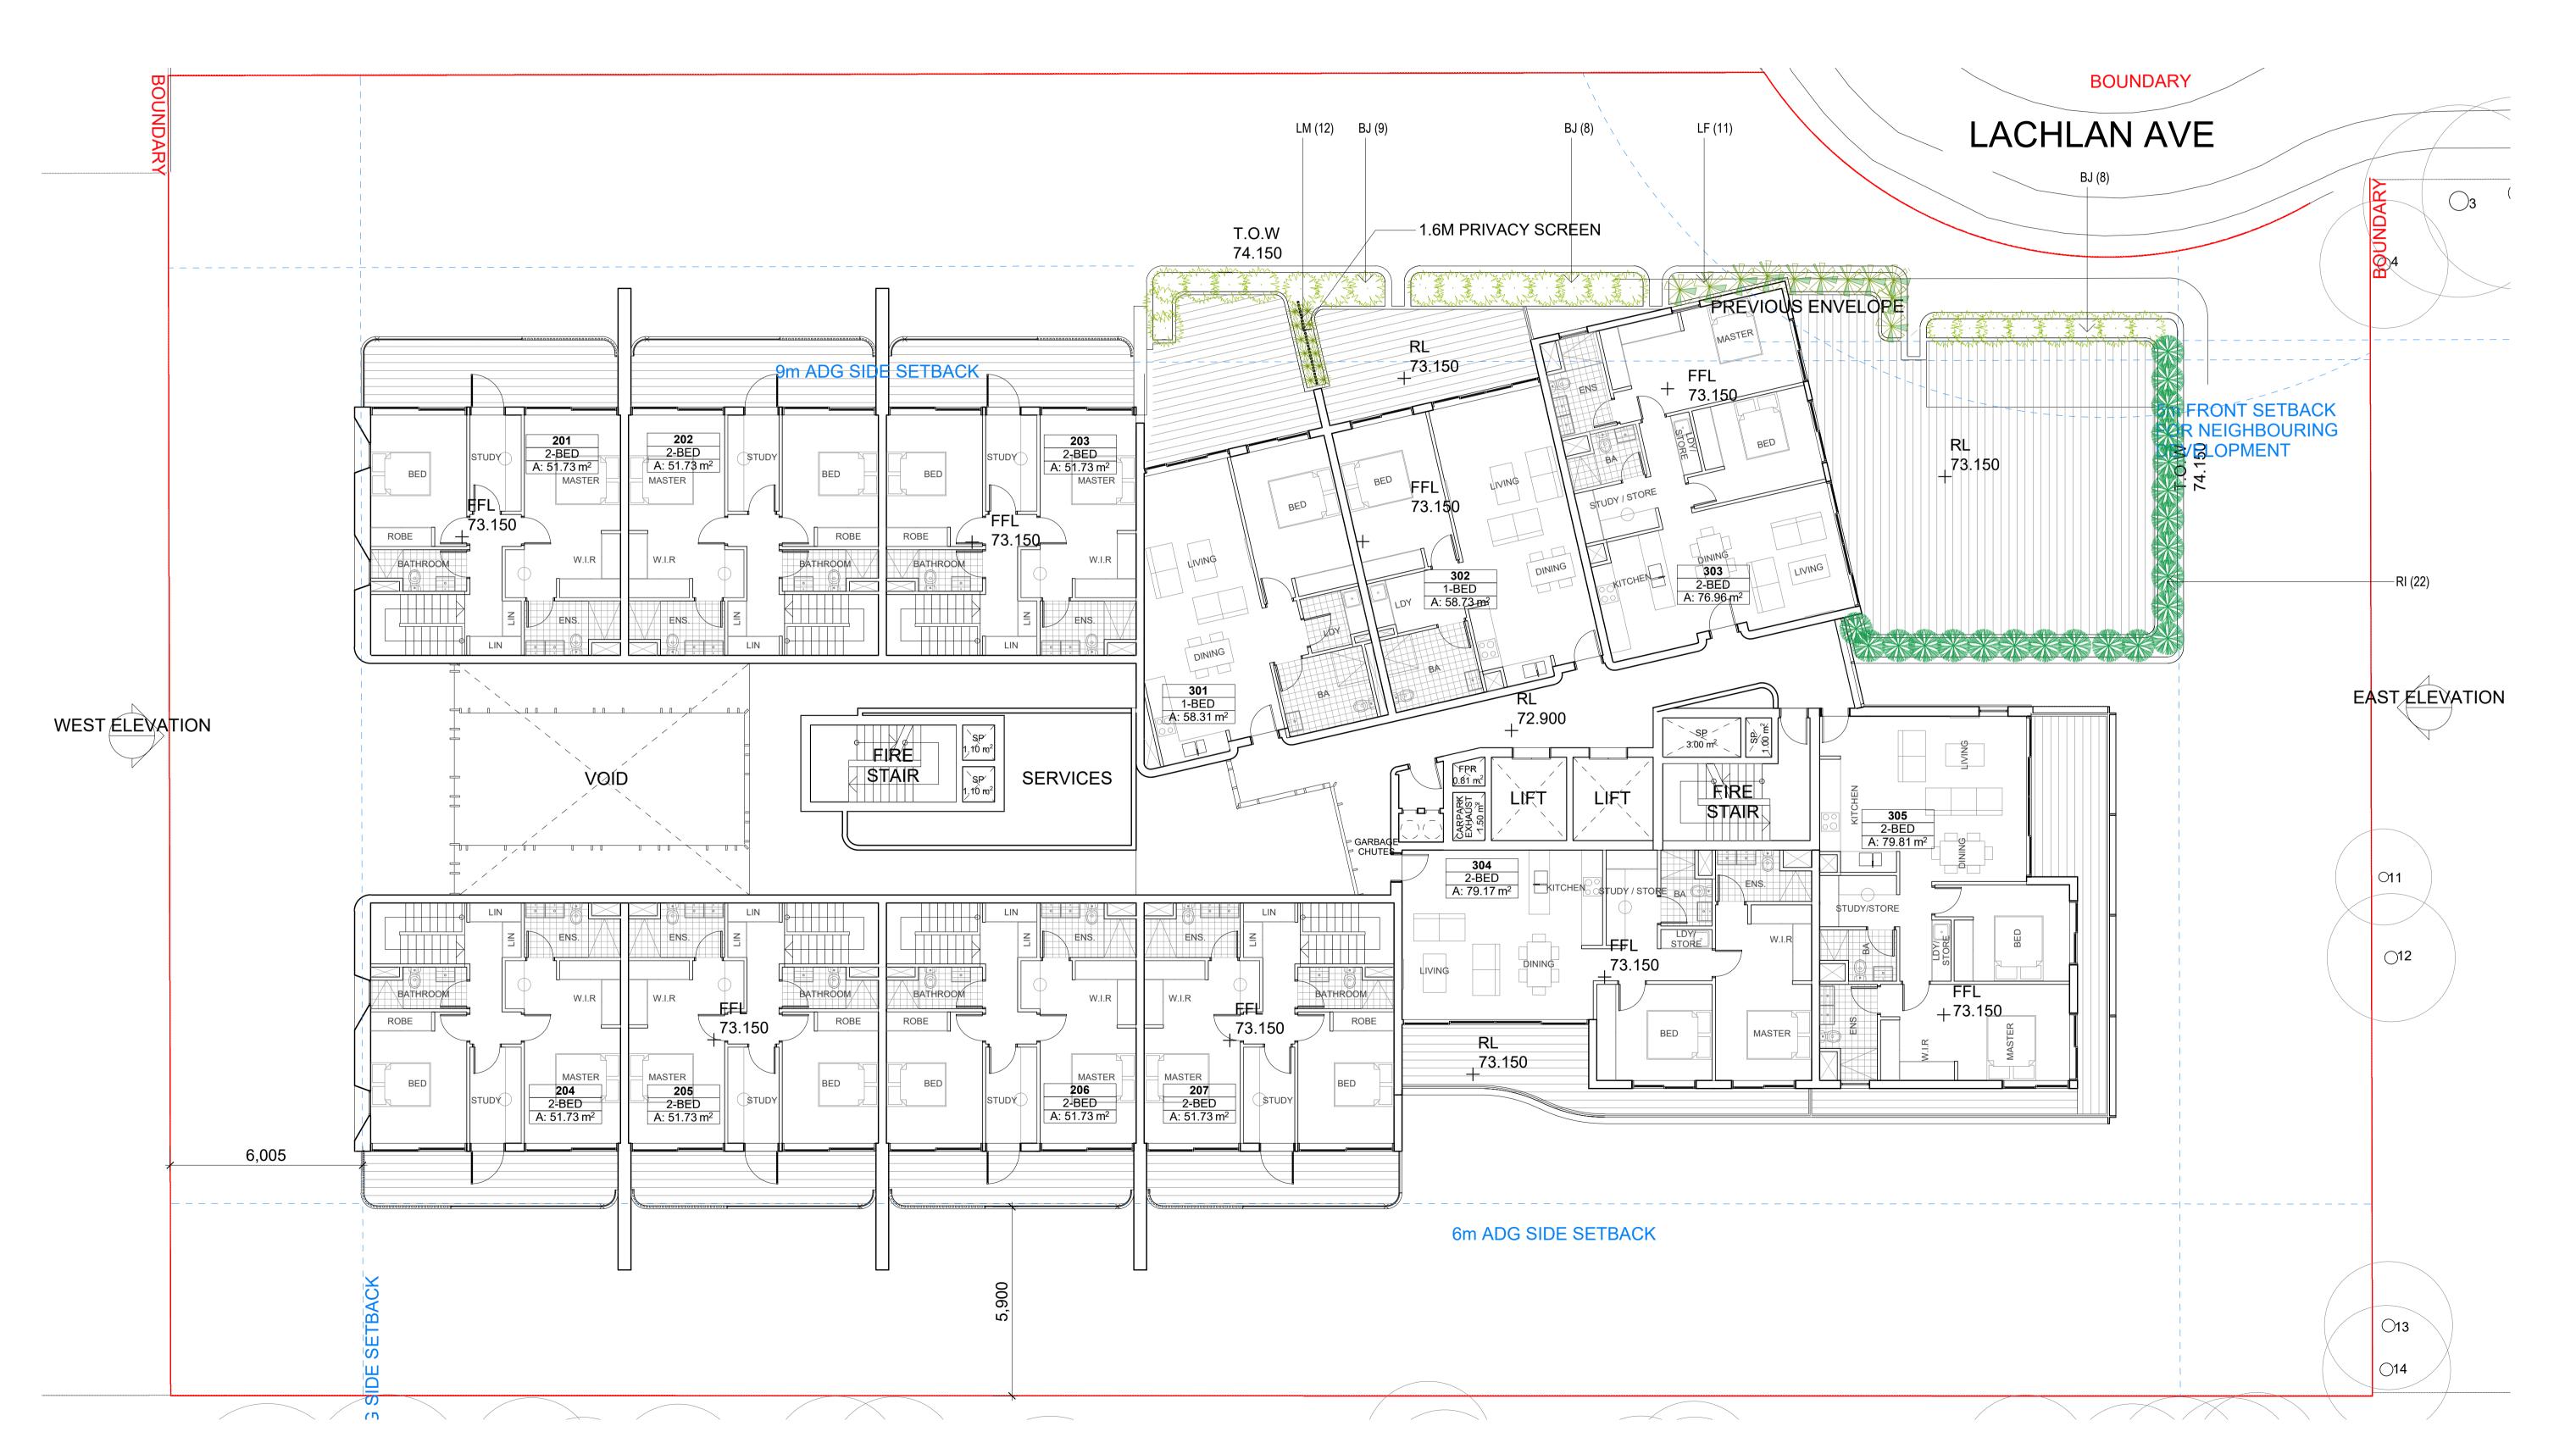
SOUTH ELEVATION

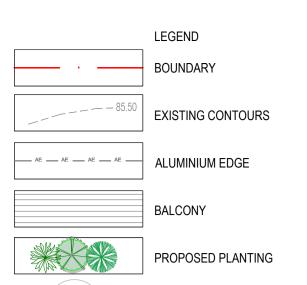
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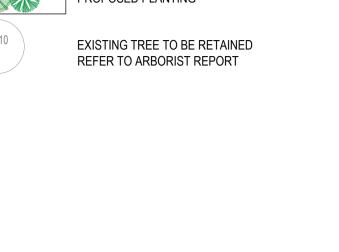
	PROPOS	SED PLANT SCHEDUI	_E		
KEY	BOTANICAL NAME	COMMON NAME	QTY	MATURE HGT	POT SIZE
	SHRUBS				
BJ	BUXUS MICROPHYLLA 'JAPONICA'	JAPANESE BOX	25	1m	250mm
RI	RHAPHIOLEPIS INDICA 'SNOW MAIDEN'	SNOW MAIDEN	22	0.8m	250mm
	GRASSES / GROUND COVERS / SUC	CULENTS			
LF	LOMANDRA FLUVIATILLIS 'SHARA'	SHARA	11	0.5m	200mm
LM	LIRIOPE MUSCARI 'JUST RIGHT'	JUST RIGHT LIRIOPE	12	0.6m	200mm







	PROPOSE	ED PLANT SCHEDULE			
KEY	BOTANICAL NAME	COMMON NAME	QTY	MATURE HGT	POT SIZE
	SHRUBS				
CV	CALLISTEMON VIMINALIS 'GREEN JOHN'	GREEN JOHN BOTTLEBRUSH	26	0.8m	250mm
RI	RHAPHIOLEPIS INDICA 'ORIENTAL PEARL'	ORIENTAL PEARL	18	1m	250mm
	GRASSES / GROUND COVERS / SUCCI	ULENTS			
CB	CRASSULA ARBORESCENS 'BLUEBIRD'	BLUEBIRD	13	0.6m	250mm
DT	DIANELLA TASMANICA 'TASRED'	TASRED DIANELLA	18	0.5m	200mm
LF	LOMANDRA FLUVIATILLIS 'SHARA'	SHARA	16	0.5m	200mm
LM	LIRIOPE MUSCARI 'JUST RIGHT'	JUST RIGHT	23	0.5m	200mm







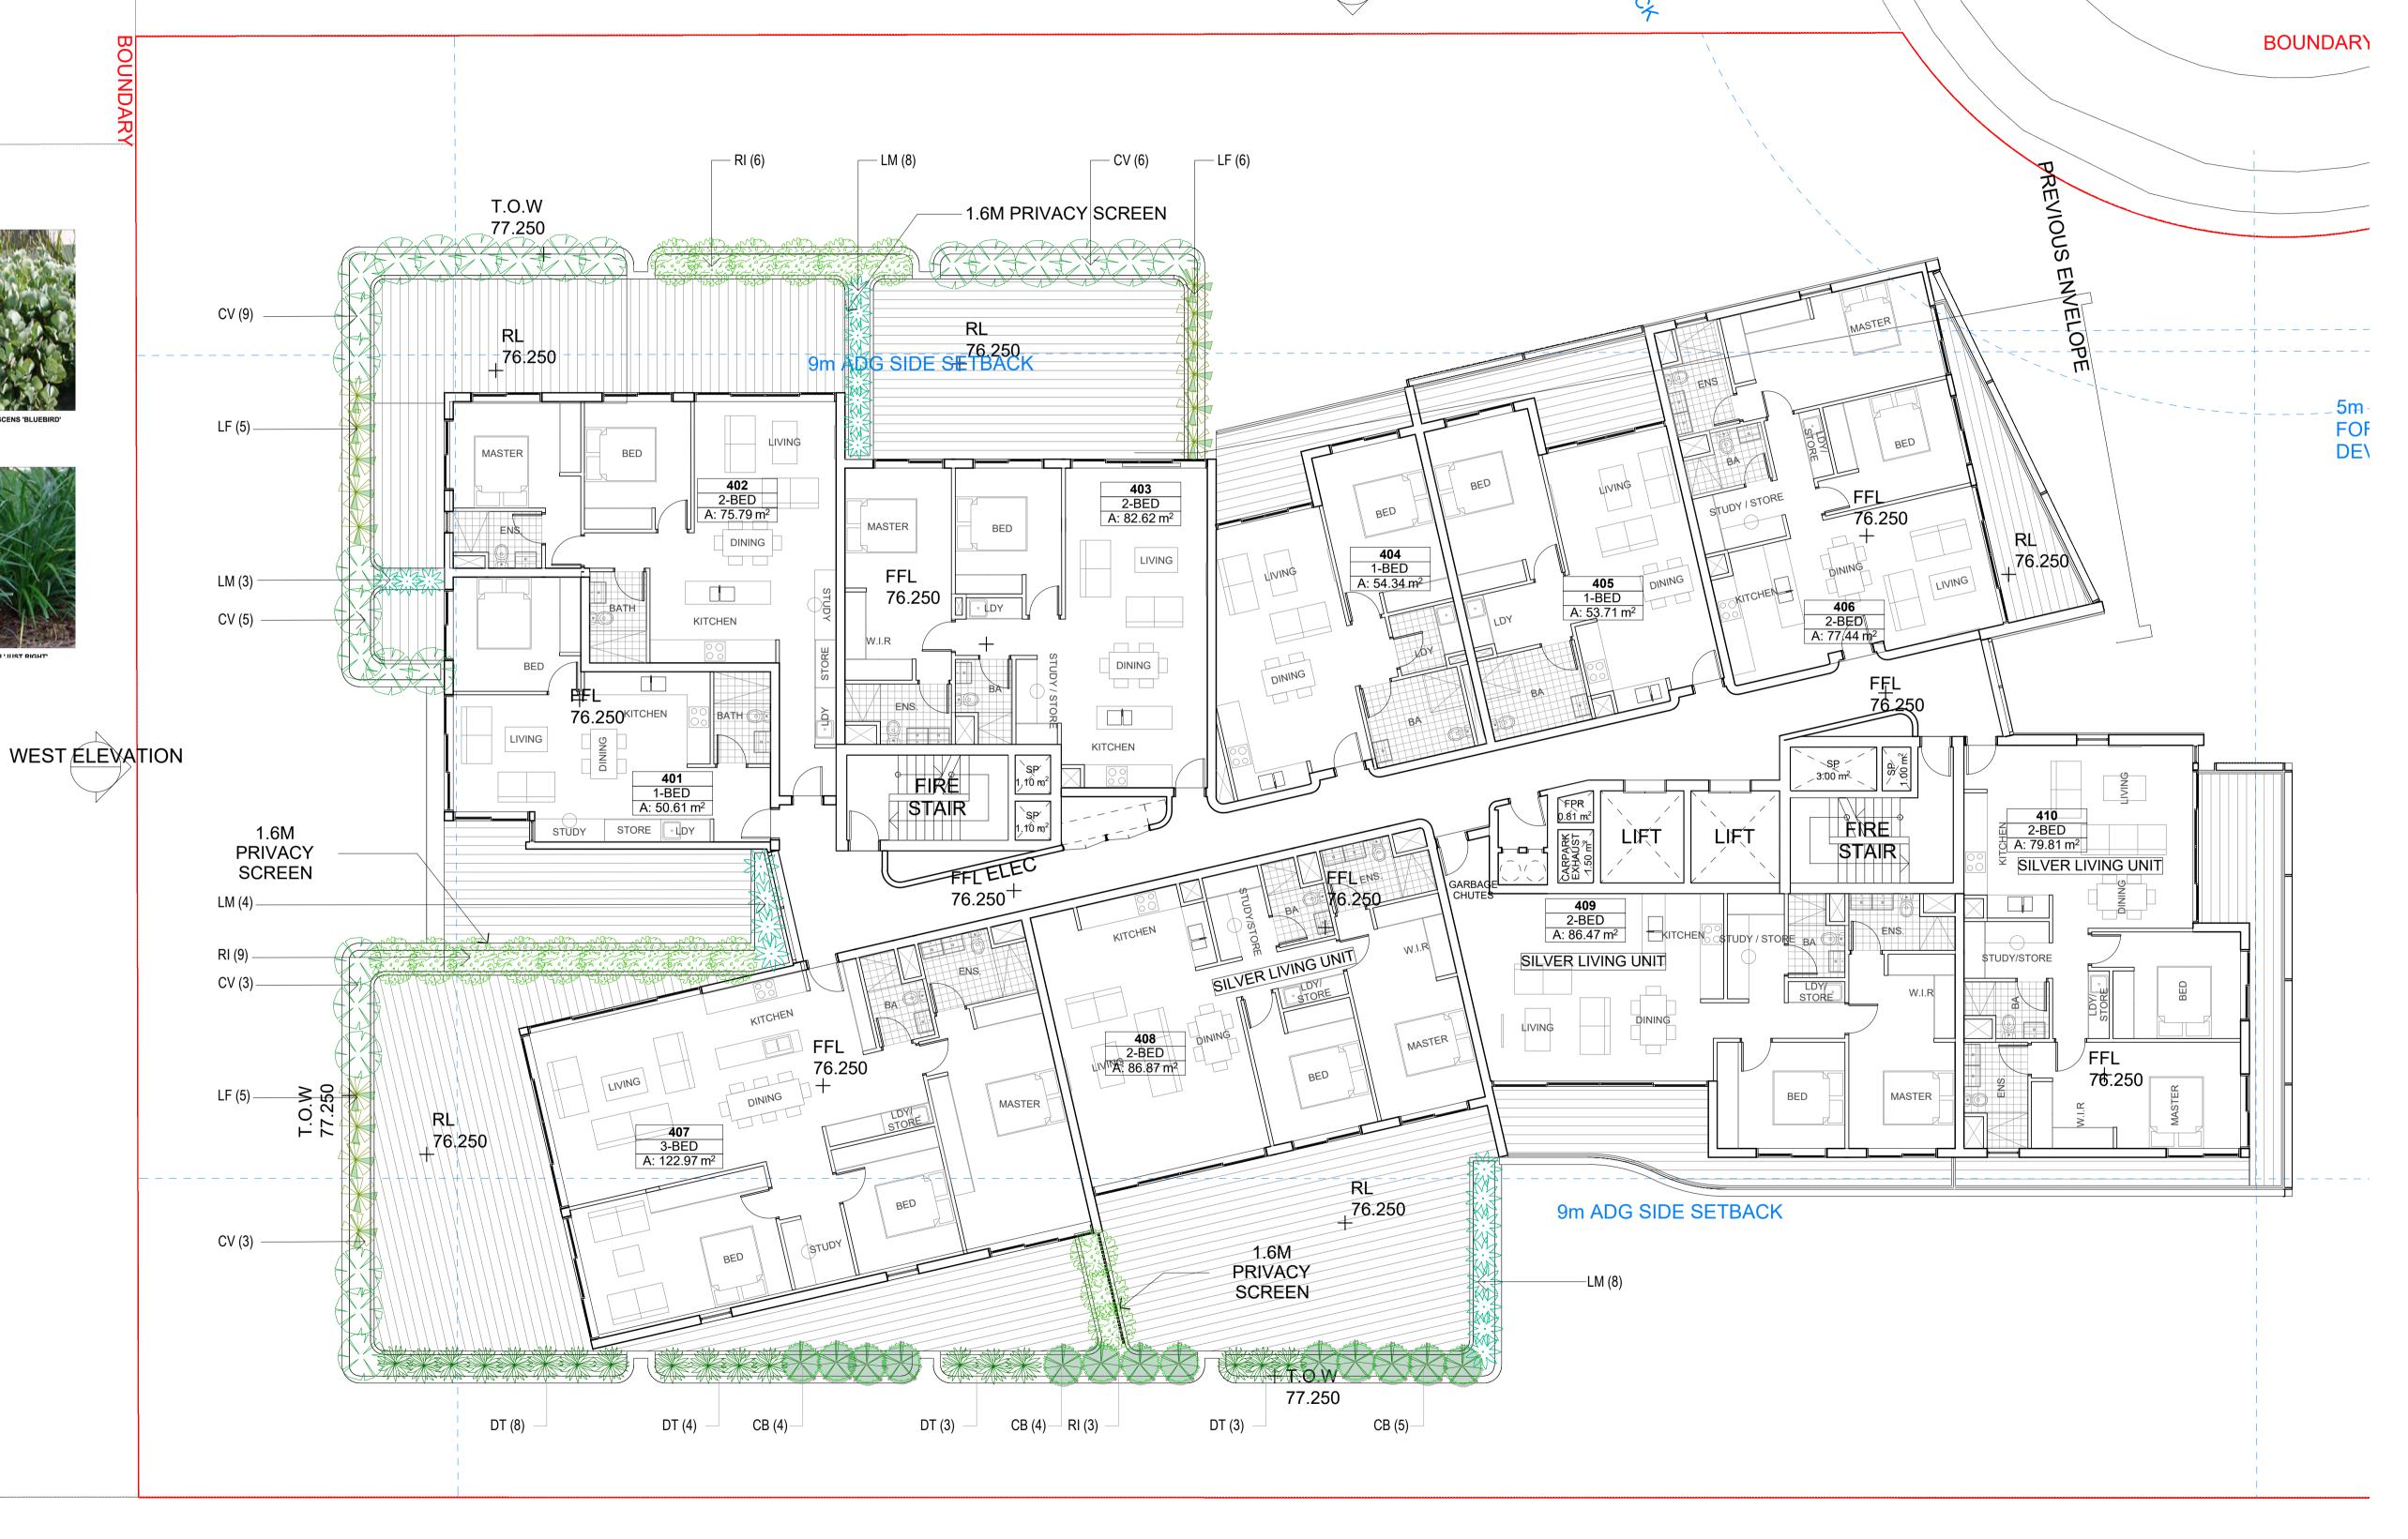












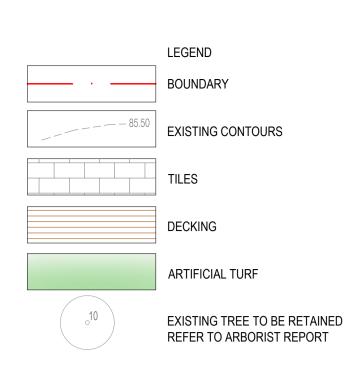
NORTH/ELEVATION











	1110100	ED PLANT SCHEDULE			
KEY	BOTANICAL NAME	COMMON NAME	QTY	MATURE HGT	POT SIZE
	TREES				
CA	CUPANIOPSIS ANACARDIOIDES	TUCKEROO	3	6m	45Ltr
MT	MAGNOLIA GRANDIFLORA 'TEDDY BEAR'	TEDDY BEAR MAGNOLIA	1	3m	45Ltr
	GRASSES / GROUND COVERS / SUCC	CULENTS			
CB	CRASSULA ARBORESCENS 'BLUEBIRD'	BLUEBIRD	2	0.6m	250mm
CO	CRASSULA OVATA 'UNDULATA'	CRASSULA	1	0.6m	250mm
LM	LIRIOPE MUSCARI 'JUST RIGHT'	JUST RIGHT	1	0.5m	200mm
PL	PHILODENDRON 'LITTLE PHIL'	LITTLE PHIL	1	0.3m	200mm
ST	SANSEVIERIA TRIFASCIATA 'LAURENTII'	MOTHER IN LAWS TONGUE	4	0.5m	250mm

PLANT PALETTE





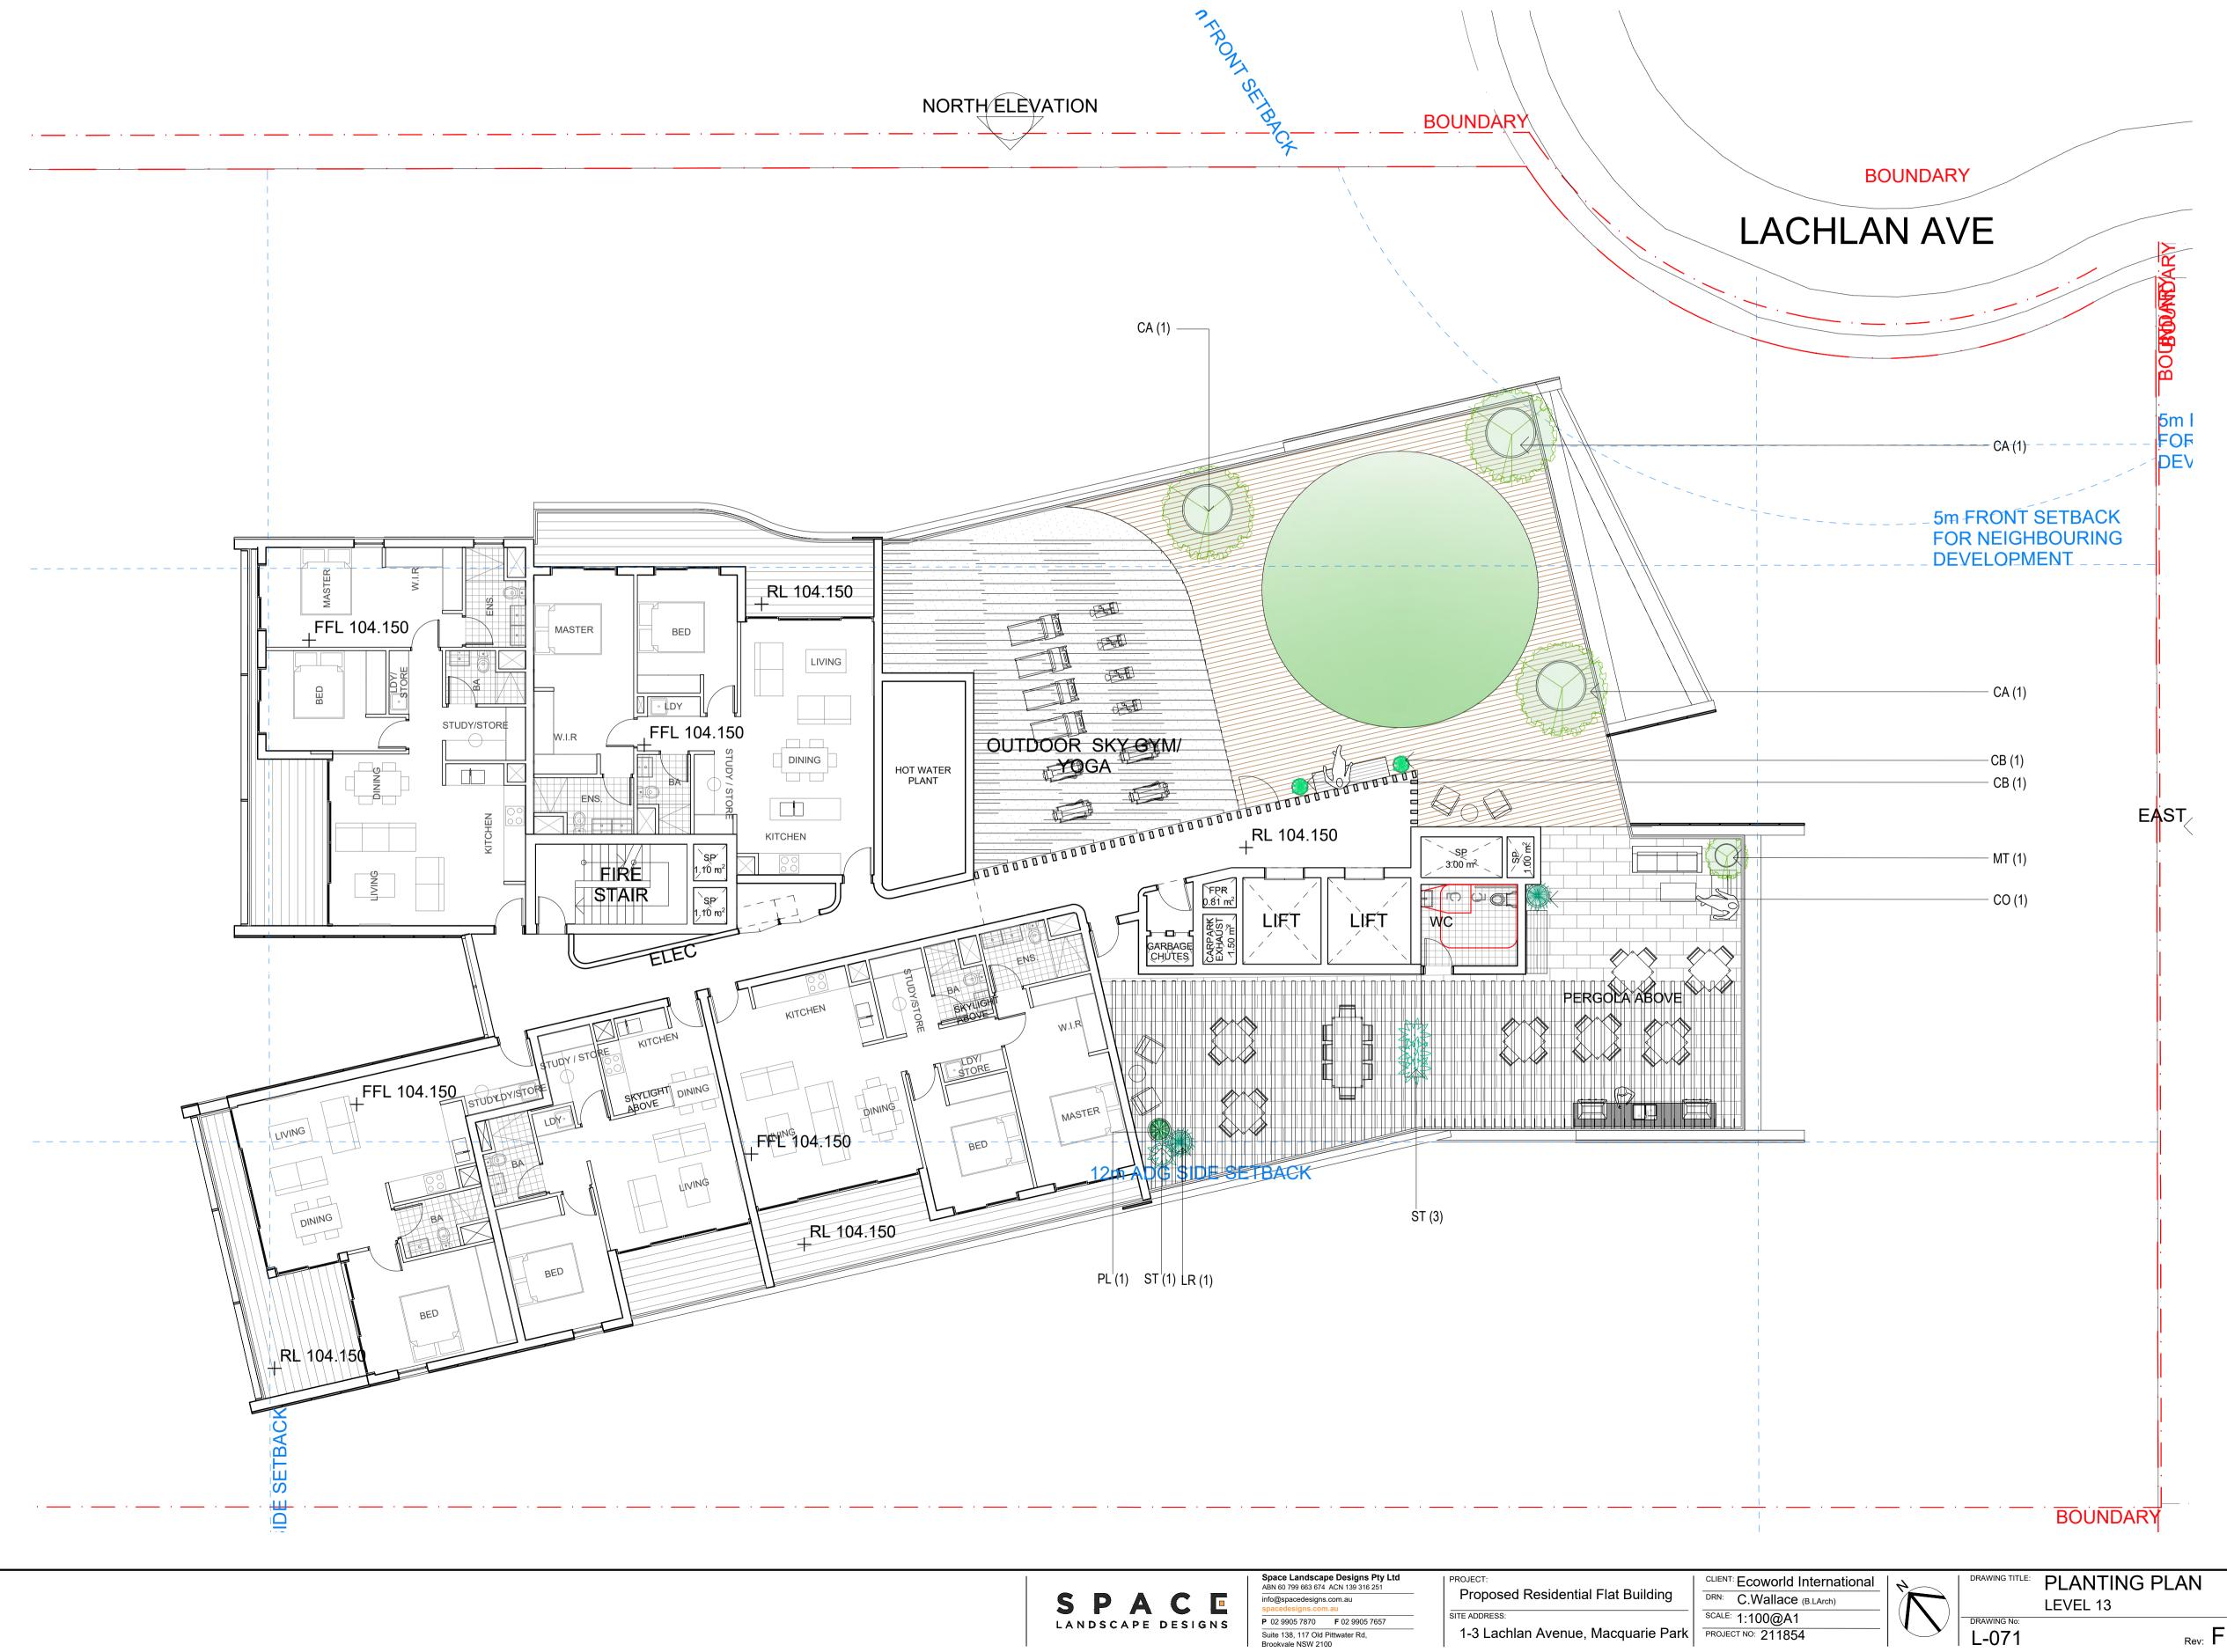








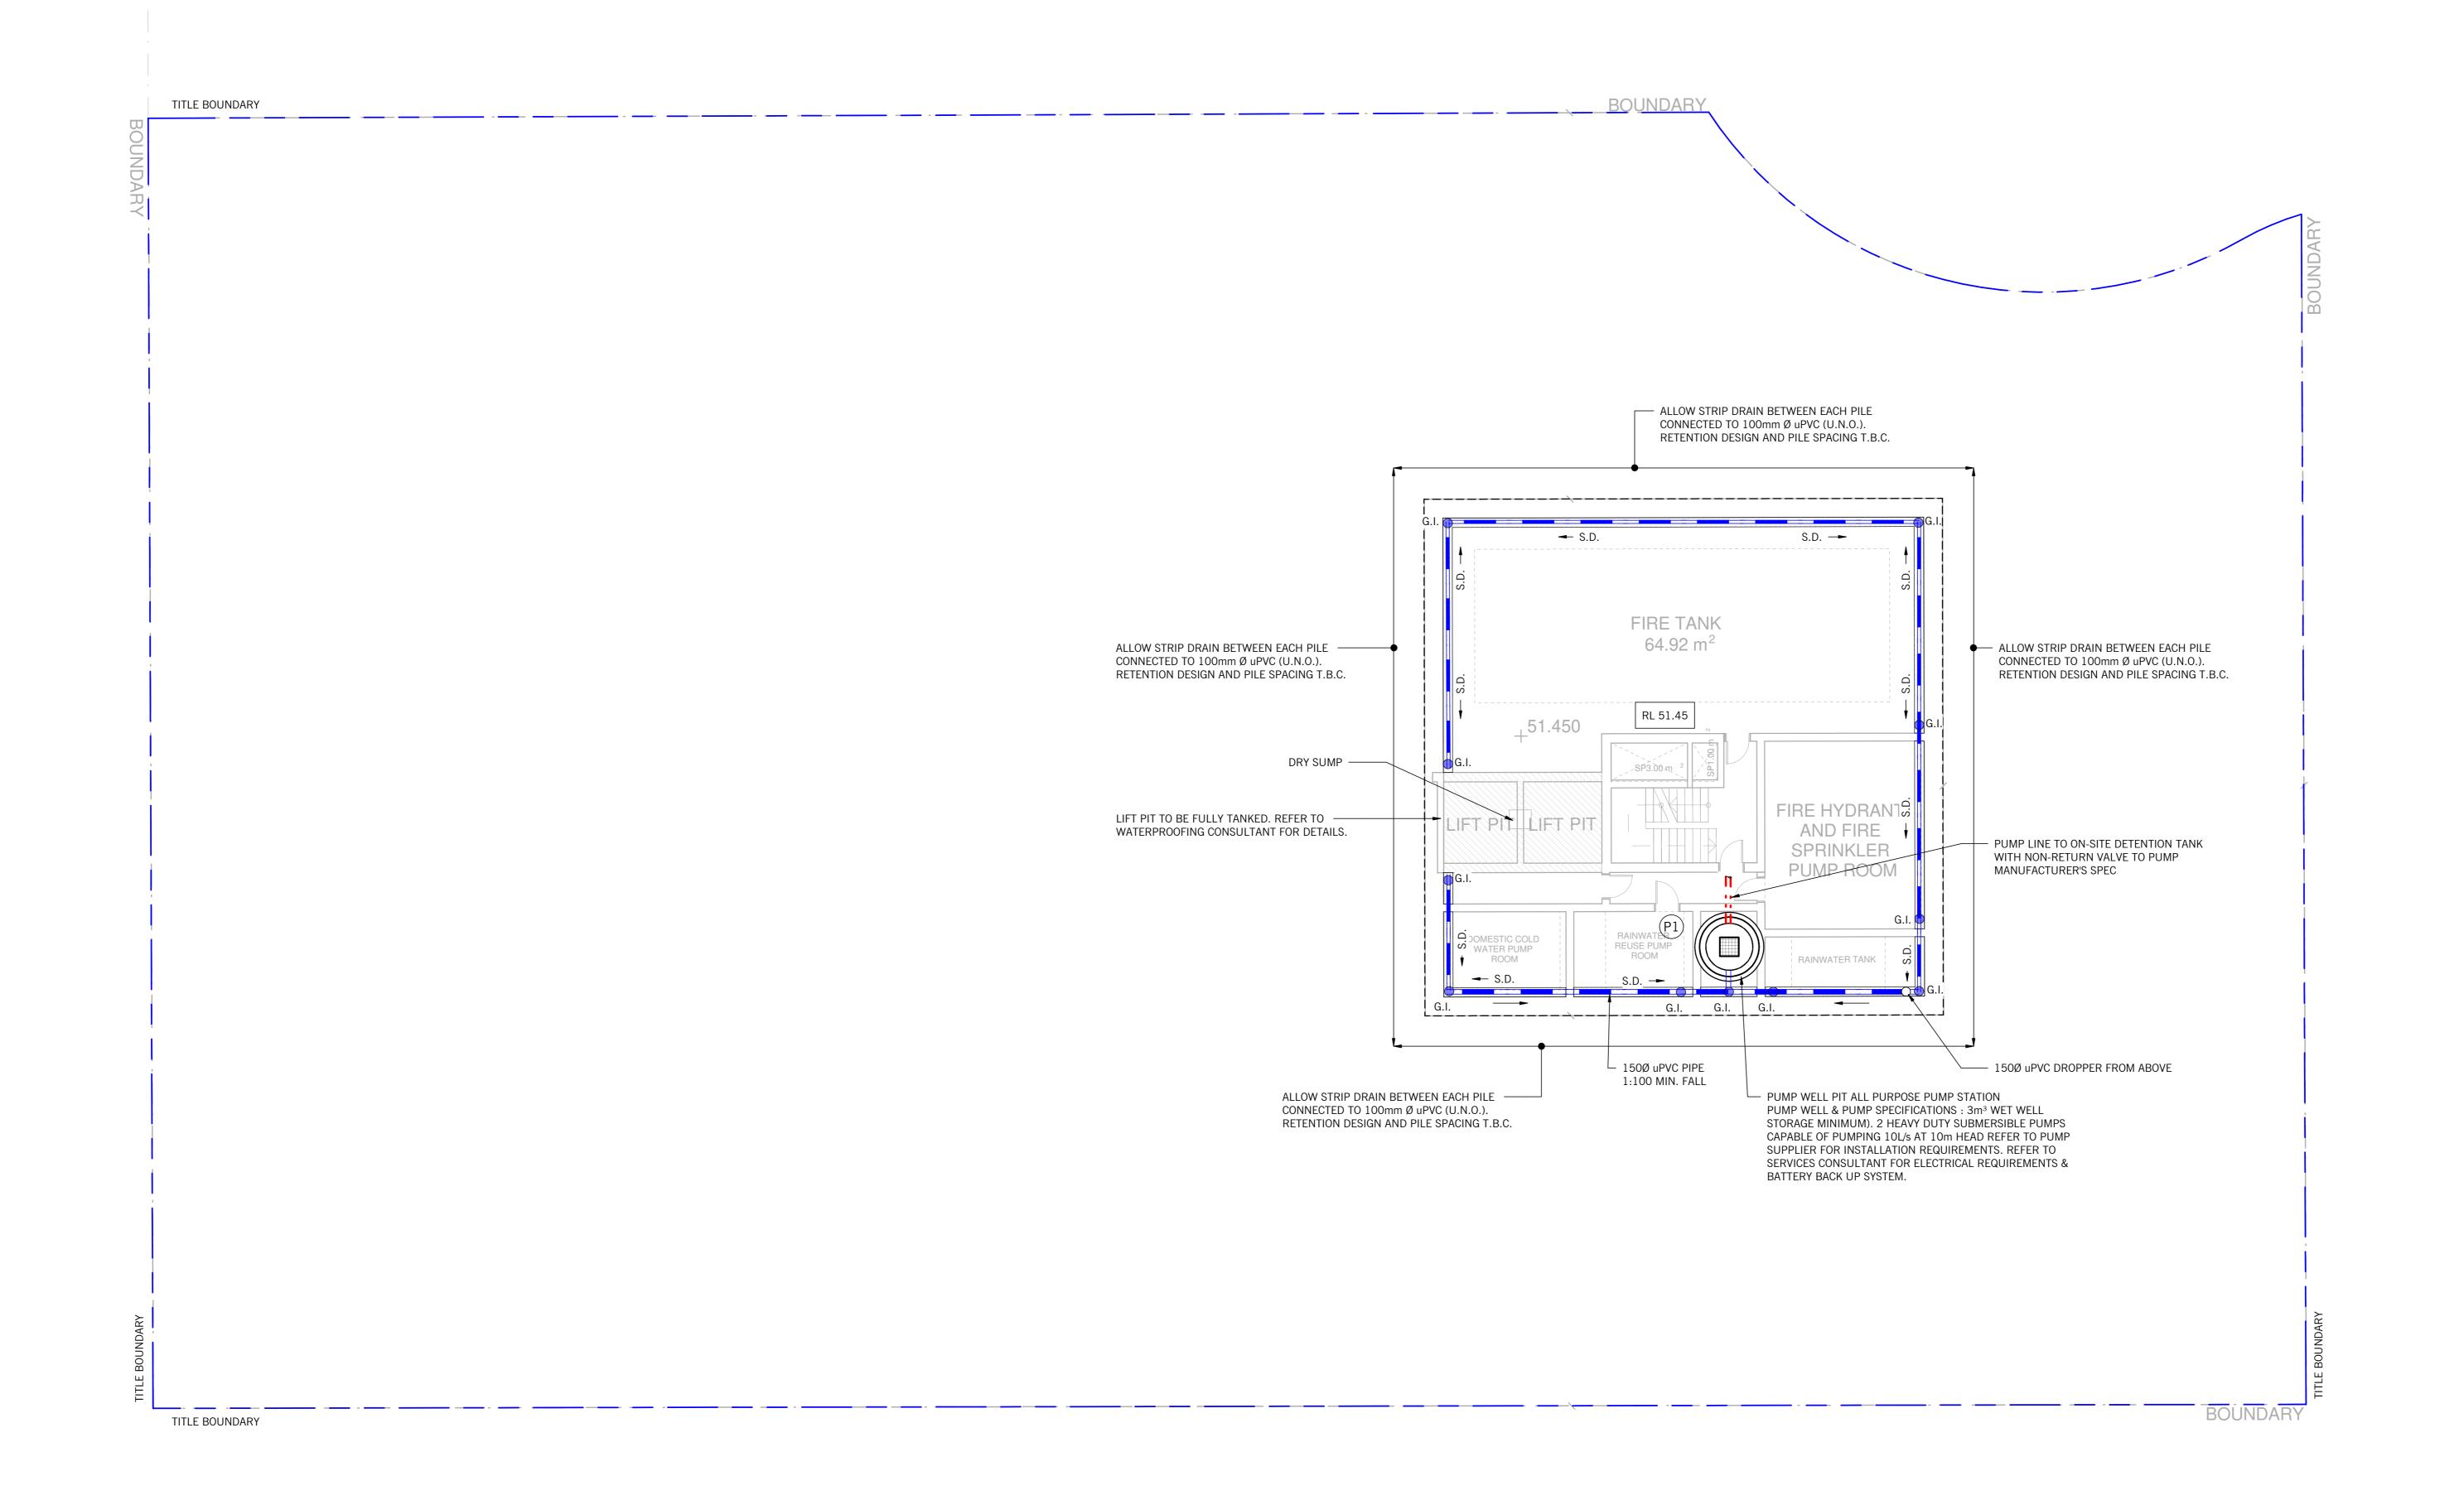




		Regulated Desi	gn	Record		
Proje	Project Address: MACQUARIE PARK, NSW					
Project Title: 1-3 LACHLAN AVENUE						
Consent No: Body Corporate Reg No:						
Drawing Title: BASEMENT 2 - DRAINAGE PLAN				Drawing No:	080	
Rev	Date dd.mm.yy	Description	ı	OP FULL NAME	Reg No	
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LEGEND		
<u>LEGEND</u>		
(Pxx)	PIT NUMBER	
	GRATED PIT	
	JUNCTION PIT	
	EXISTING JUNCTION PIT	
	EXISTING SIDE ENTRY PIT	
I.O. •	INSPECTION OPENING	
G.I. O	GRATED INLET	
	FALL DIRECTION	
<u> </u>	VERTICAL STRIP DRAIN	
·—	VERTICAL HARD PIPE	
	STORMWATER PIPE	
	STORMWATER PIPE LAID OVER OR UNDER	
	100 DIA. AGRICULTURAL DRAIN LAID TO 1:100 FALL	
	AGI. DRAIN LAID OVER OR UNDER	
	PUMP OUT FLOW DRAIN LINE	
S.D.	RISING MAIN LINE	
	SPOON DRAIN	
74 5 7 4	NEW PAVEMENT	
	NEW LANDSCAPING	
+EX. 00.00	EXISTING SURFACE LEVEL	
+P. 00.00	EXISTING SURFACE LEVEL	
= = = <u>Ex K&C</u> = = = = = = = = = = = = = = = = = = =	EXISTING KERB & CHANNEL	
K&C	NEW KERB & CHANNEL TO COUNCIL REQUIREMENTS	
s	EXISTING SEWER	
D	EXISTING STORMWATER	
—— Е ——	EXISTING ELECTRICITY	
G	EXISTING GAS	
т —— т	EXISTING TELECOMMUNICATION	
——— w ———	EXISTING WATER MAIN	
	ON-SITE DETENTION TANK	

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BASEMENT 2 - DRAINAGE PLAN

			STORM	MWATER PIT SCHEDUI	_E	
MARK	TYPE	SIZE	COVER TYPE	COVER CLASS	COVER LEVEL	REMARKS
P1	JUNCTION	1500 DIA.	GRATED	AS PER AS3996, HEELGUARD	51.45	PUMP WELL PIT
P2	JUNCTION	600 x 600	GRATED	AS PER AS3996, HEELGUARD	55.15	
P3	JUNCTION	600 x 600	GRATED	AS PER AS3996, HEELGUARD	55.15	
P4	JUNCTION	900 x 900	GRATED	AS PER AS3996, HEELGUARD	54.55	
P5	JUNCTION	900 x 900	GRATED	AS PER AS3996, HEELGUARD	54.55	
P6	JUNCTION	600 x 600	GRATED	AS PER AS3996, HEELGUARD	54.55	
P7	JUNCTION	600 x 600	GRATED	AS PER AS3996, HEELGUARD	54.55	
P8	JUNCTION	900 x 900	GRATED	AS PER AS3996, HEELGUARD	58.86	PROVIDE SPEL STORMSA
P9	JUNCTION	900 x 900	GRATED	AS PER AS3996, HEELGUARD	57.45	SURCHARGE PIT
P10	JUNCTION	900 x 900	GRATED	AS PER AS3996, HEELGUARD	62.00	PROVIDE SPEL STORMSA
P11	JUNCTION	600 x 600	GRATED	AS PER AS3996, HEELGUARD	64.63	PROVIDE SPEL STORMSA
P12	JUNCTION	600 x 600	GRATED	AS PER AS3996, HEELGUARD	63.68	PROVIDE SPEL STORMSA
P13	JUNCTION	600 x 600	GRATED	AS PER AS3996, HEELGUARD	TBC	PROVIDE SPEL STORMSA
P14	JUNCTION	900 x 900	GRATED	AS PER AS3996, HEELGUARD	TBC	PROVIDE SPEL STORMSA
P15	JUNCTION	600 x 600	GRATED	AS PER AS3996, HEELGUARD	TBC	PROVIDE SPEL STORMSA
P16	JUNCTION	900 x 900	GATIC	SOLID COVER	TBC	PROVIDE SPEL STORMSA

City of Ryde Development Engineering Service Approved Engineering Plans Application Number:LDA2021/0187 Council Officer:Emily Lu Date: 23/09/2022



1. THIS DRAINAGE DESIGN IS BASED ON LPD ADVICE BY <u>CITY OF RYDE</u> DATED <u>29/09/20</u>, REFERENCE DANIEL PEARSE AND IS SUBJECT TO AUTHORITY REVIEW AND APPROVAL. BUILDER TO MAKE

2. FOOTPATH RL SUBJECT TO ARCHITECTURAL AND COUNCIL REVIEW. BUILDER TO MAKE NECESSARY ALLOWANCE WHERE DEEMED REQUIRED. (ALL LEVELS APPROXIMATE BASED FROM <u>HAMMOND</u>

EXCAVATION, PENDING GEOTECHNICAL REPORT. SHOULD GROUND WATER BE IDENTIFIED WITHIN REPORT A RE-DESIGN OF BASEMENT DRAINAGE SYSTEM MAY BE REQUIRED WITH POTENTIAL

4. THE DESIGN ASSUMES THAT HYDRAULIC DOWN PIPES AND OVERFLOWS INCLUDING TEST DRAINS ARE NOT CONNECTED TO THE BASEMENT DRAINAGE SYSTEMS. SHOULD DOWN PIPES AND OVERFLOWS ARE CONNECTED TO THE BASEMENT, A RE-DESIGN OF BASEMENT DRAINAGE SYSTEM MAY BE REQUIRED. TOTAL FLOW RATES, FLOW DURATION AND AVERAGE RECURRENCE INTERVAL

7. SUBJECT TO RECEIPT AND REVIEW OF HYDRAULICS AND FIRE SERVICE CONSTRUCTION ISSUED

8. SUBJECT TO RECEIVED UP TO DATE FEATURE LEVEL SURVEY AND IN GROUND SERVICES SURVEY. 9. FOR ANY PUBLIC DOMAIN WORKS OUTSIDE THE BUILDING AND SITE BOUNDARY, BUILDERS TO MAKE ALLOWANCE TO ENGAGE SPECIALIST CONTRACTOR TO CARRY OUT FOR THE ADDITIONAL WORKS. DETAILED DESIGN SUCH AS CROSSOVER, KERB AND CHANNEL, NATURE STRIP, STREET FURNITURE AND FOOTPATH MUST BE IN ACCORDANCE AND APPROVED BY COUNCIL AND ITS RELEVANT AUTHORITIES PRIOR COMMENCEMENT OF ANY WORK. REFER TO PLANNING OR

10. ANY CHANGES TO THE COUNCIL APPROVE LEGAL POINT OF DISCHARGE CONNECTION EITHER DUE TO LATENT CONDITIONS OR DESIGN CHANGES MUST BE APPROVED BY COUNCIL PRIOR TO COMMENCEMENT OF ANY WORKS. BUILDER OR CIVIL CONTRACTOR TO LIASE DIRECT WITH THE

3. THE DESIGN ASSUMES THAT GROUND WATER IS NOT ENCOUNTERED WITHIN THE BASEMENT

NECESSARY ALLOWANCE WHERE DEEM REQUIRED.

SEALED BASEMENT.

<u>SMEALLIE & CO PTY LTD</u> REF : <u>14344</u> DATED : <u>14/05/18</u>)

(ARI) MUST BE PROVIDED BY RELEVANT CONSULTANTS.

6. SUBJECT TO REVIEW BY TRAFFIC ENGINEER.

DRAWINGS FOR COORDINATION.

EXISTING SERVICES NOTES:

PRIOR COMMENCEMENT OF ANY WORKS.

5. SUBJECT TO VERIFICATION OF THE GROUNDWATER DEPTH ON SITE.

DEVELOPMENT APPLICATION AND DISABILITY ACCESS REQUIREMENT.

RELEVANT COUNCIL ENGINEER FOR ALL NECESSARY APPROVALS.

BUILDER TO CONFIRM EXACT LOCATION, DEPTH AND SIZE OF EXISTING SERVICES

ALL IN-GROUND STORMWATER TO BE INSPECTED BY A QUALIFIED REGISTERED CIVIL ENGINEER ARRANGED BY BUILDER OR CIVIL CONTRACTOR ON SITE. ALL IN-GROUND STORMWATER INSPECTIONS ARE NOT WEBBER DESIGN SCOPE. PROVIDE REG126 INSPECTION FOR ALL INSTALLED IN GROUND

ANY CHANGES TO THE COUNCIL APPROVE LEGAL POINT OF DISCHARGE CONNECTION EITHER DUE TO LATENT CONDITIONS OR DESIGN CHANGES MUST BE APPROVED BY COUNCIL PRIOR TO COMMENCEMENT OF ANY

WORKS. BUILDER OR CIVIL CONTRACTOR TO LIASE DIRECT WITH THE

RELEVANT COUNCIL ENGINEER FOR ALL NECESSARY APPROVALS.

INVERT LEVELS ARE SUBJECT TO FINAL STRUCTURAL DESIGN

IF ANY PROPOSED DRAINAGE SYSTEM INTERSECT WITH EXISTING SERVICES,

CONTACT WEBBER DESIGN OFFICE FOR FURTHER ASSESSMENT.

STORMWATER TO AUTHORITY PLANNING PERMIT REQUIREMENTS

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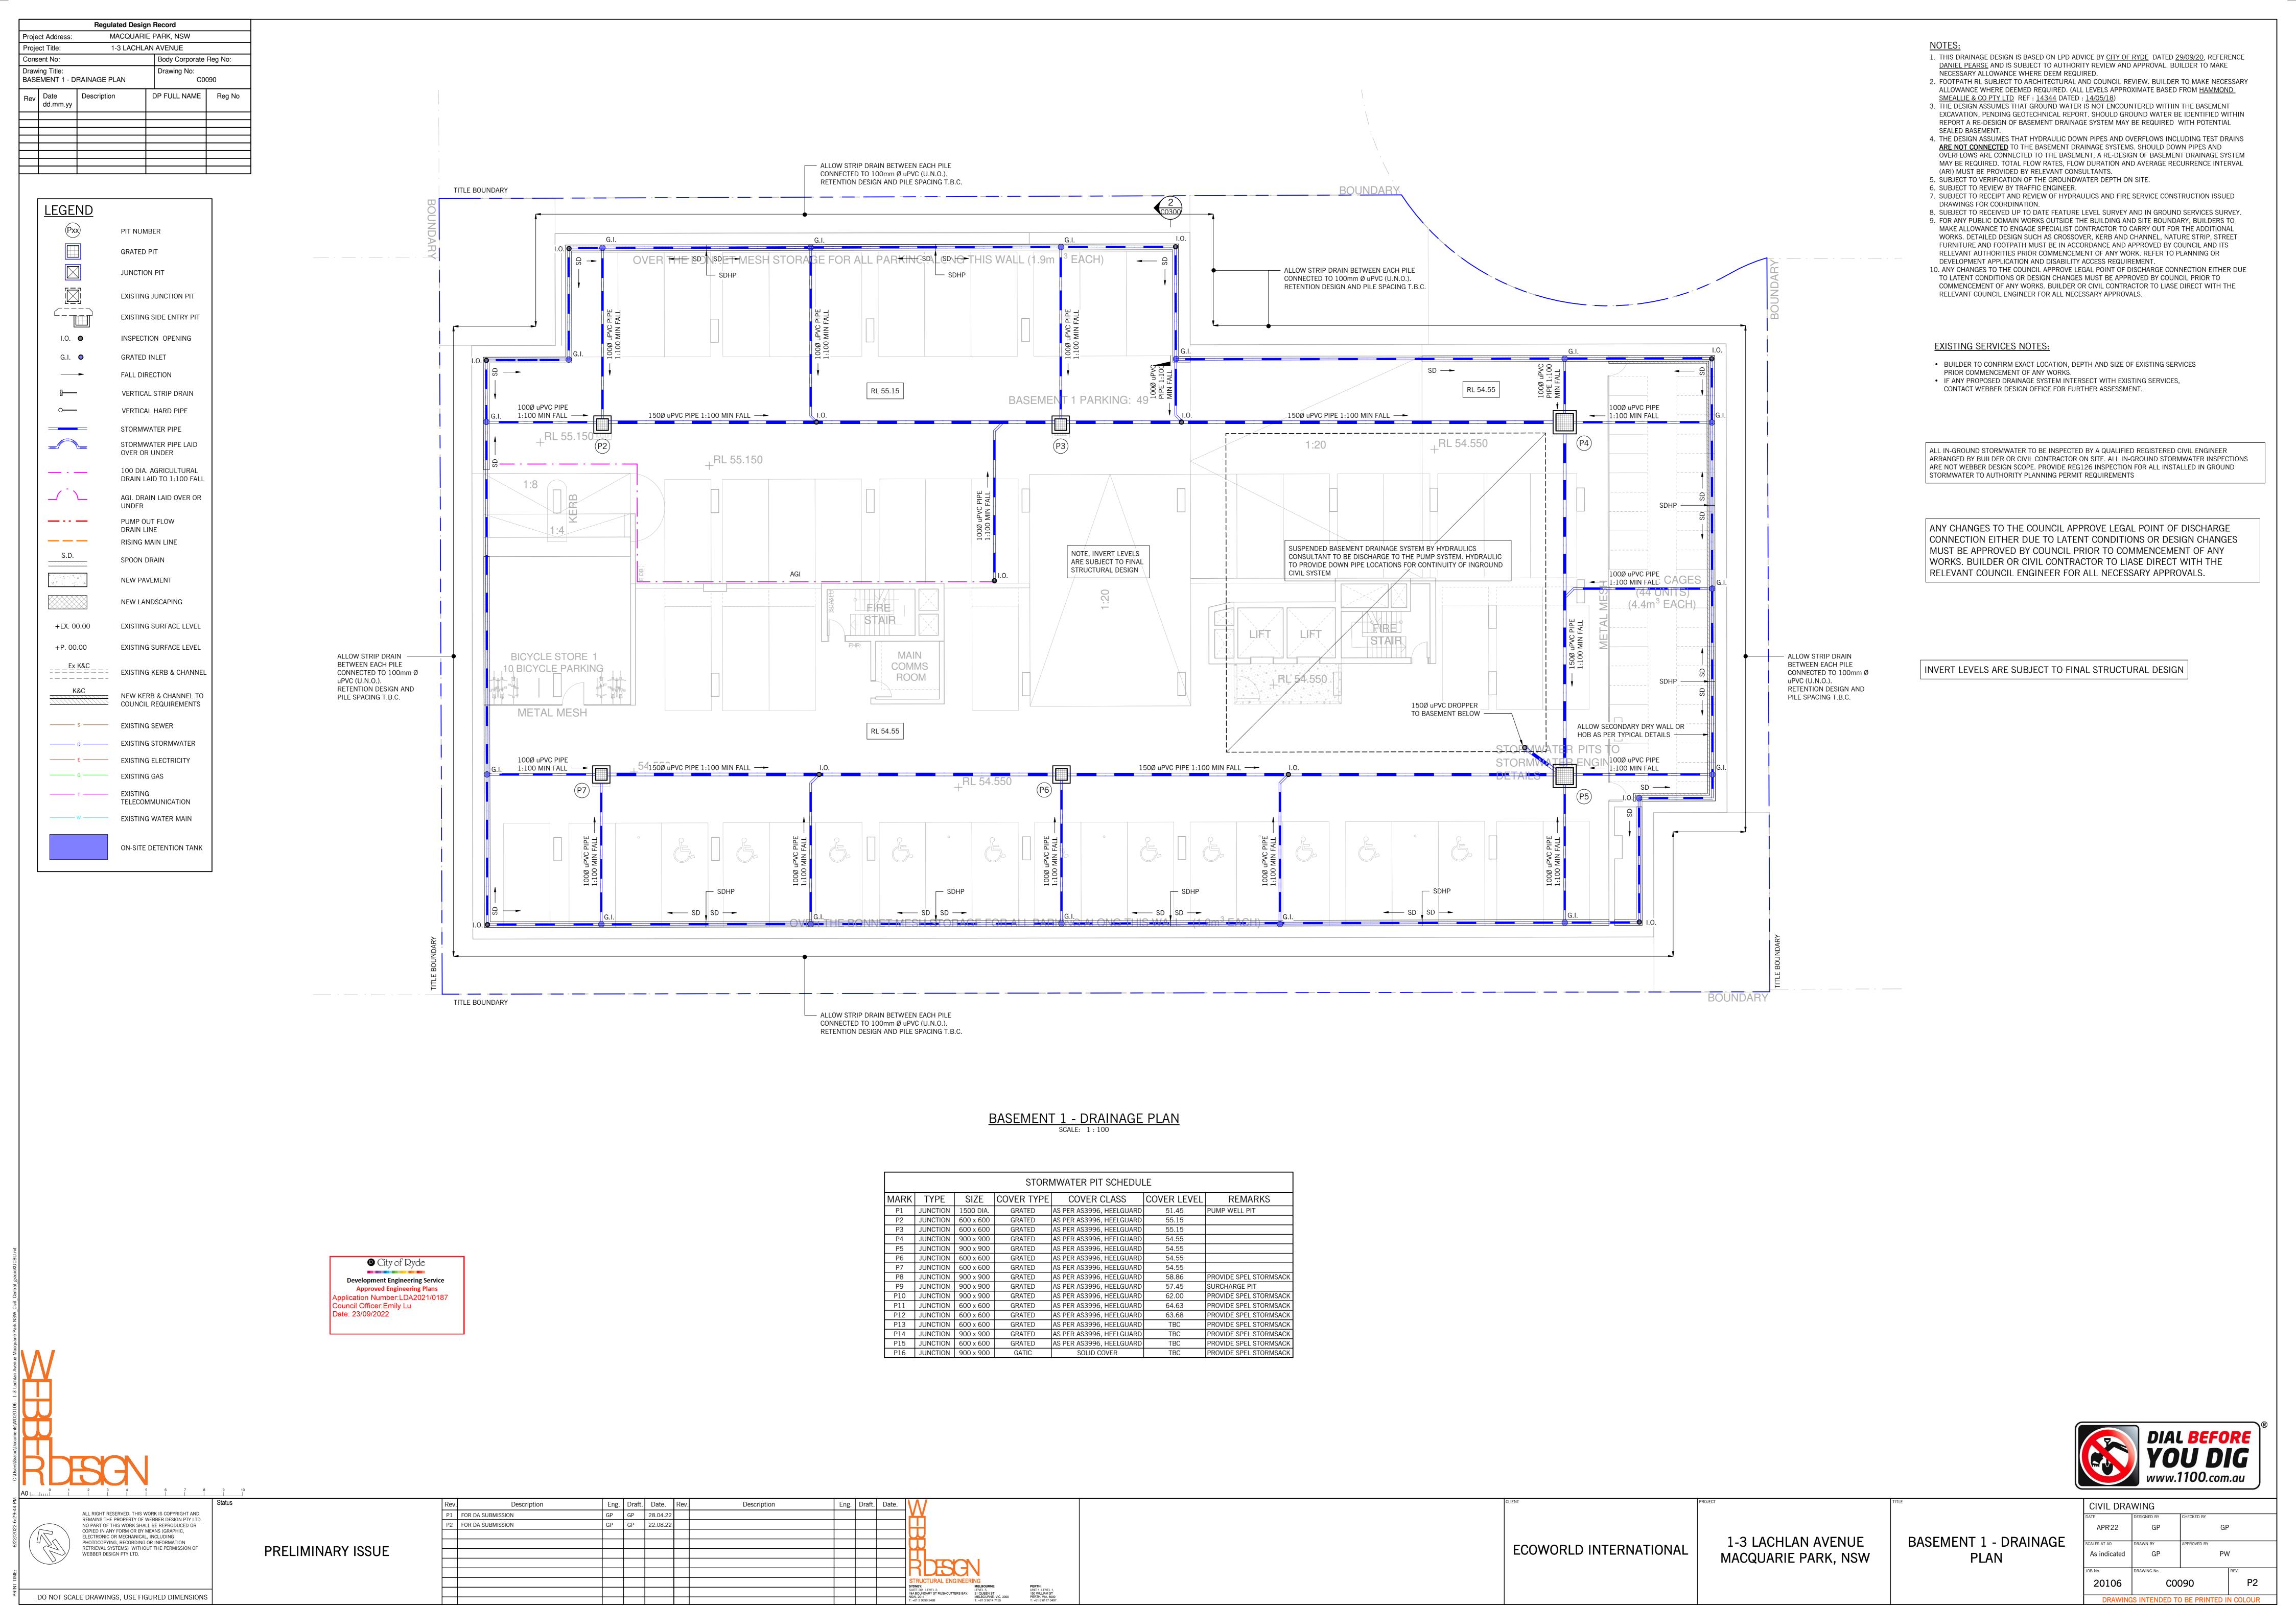
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BASEMENT 2 - DRAINAGE

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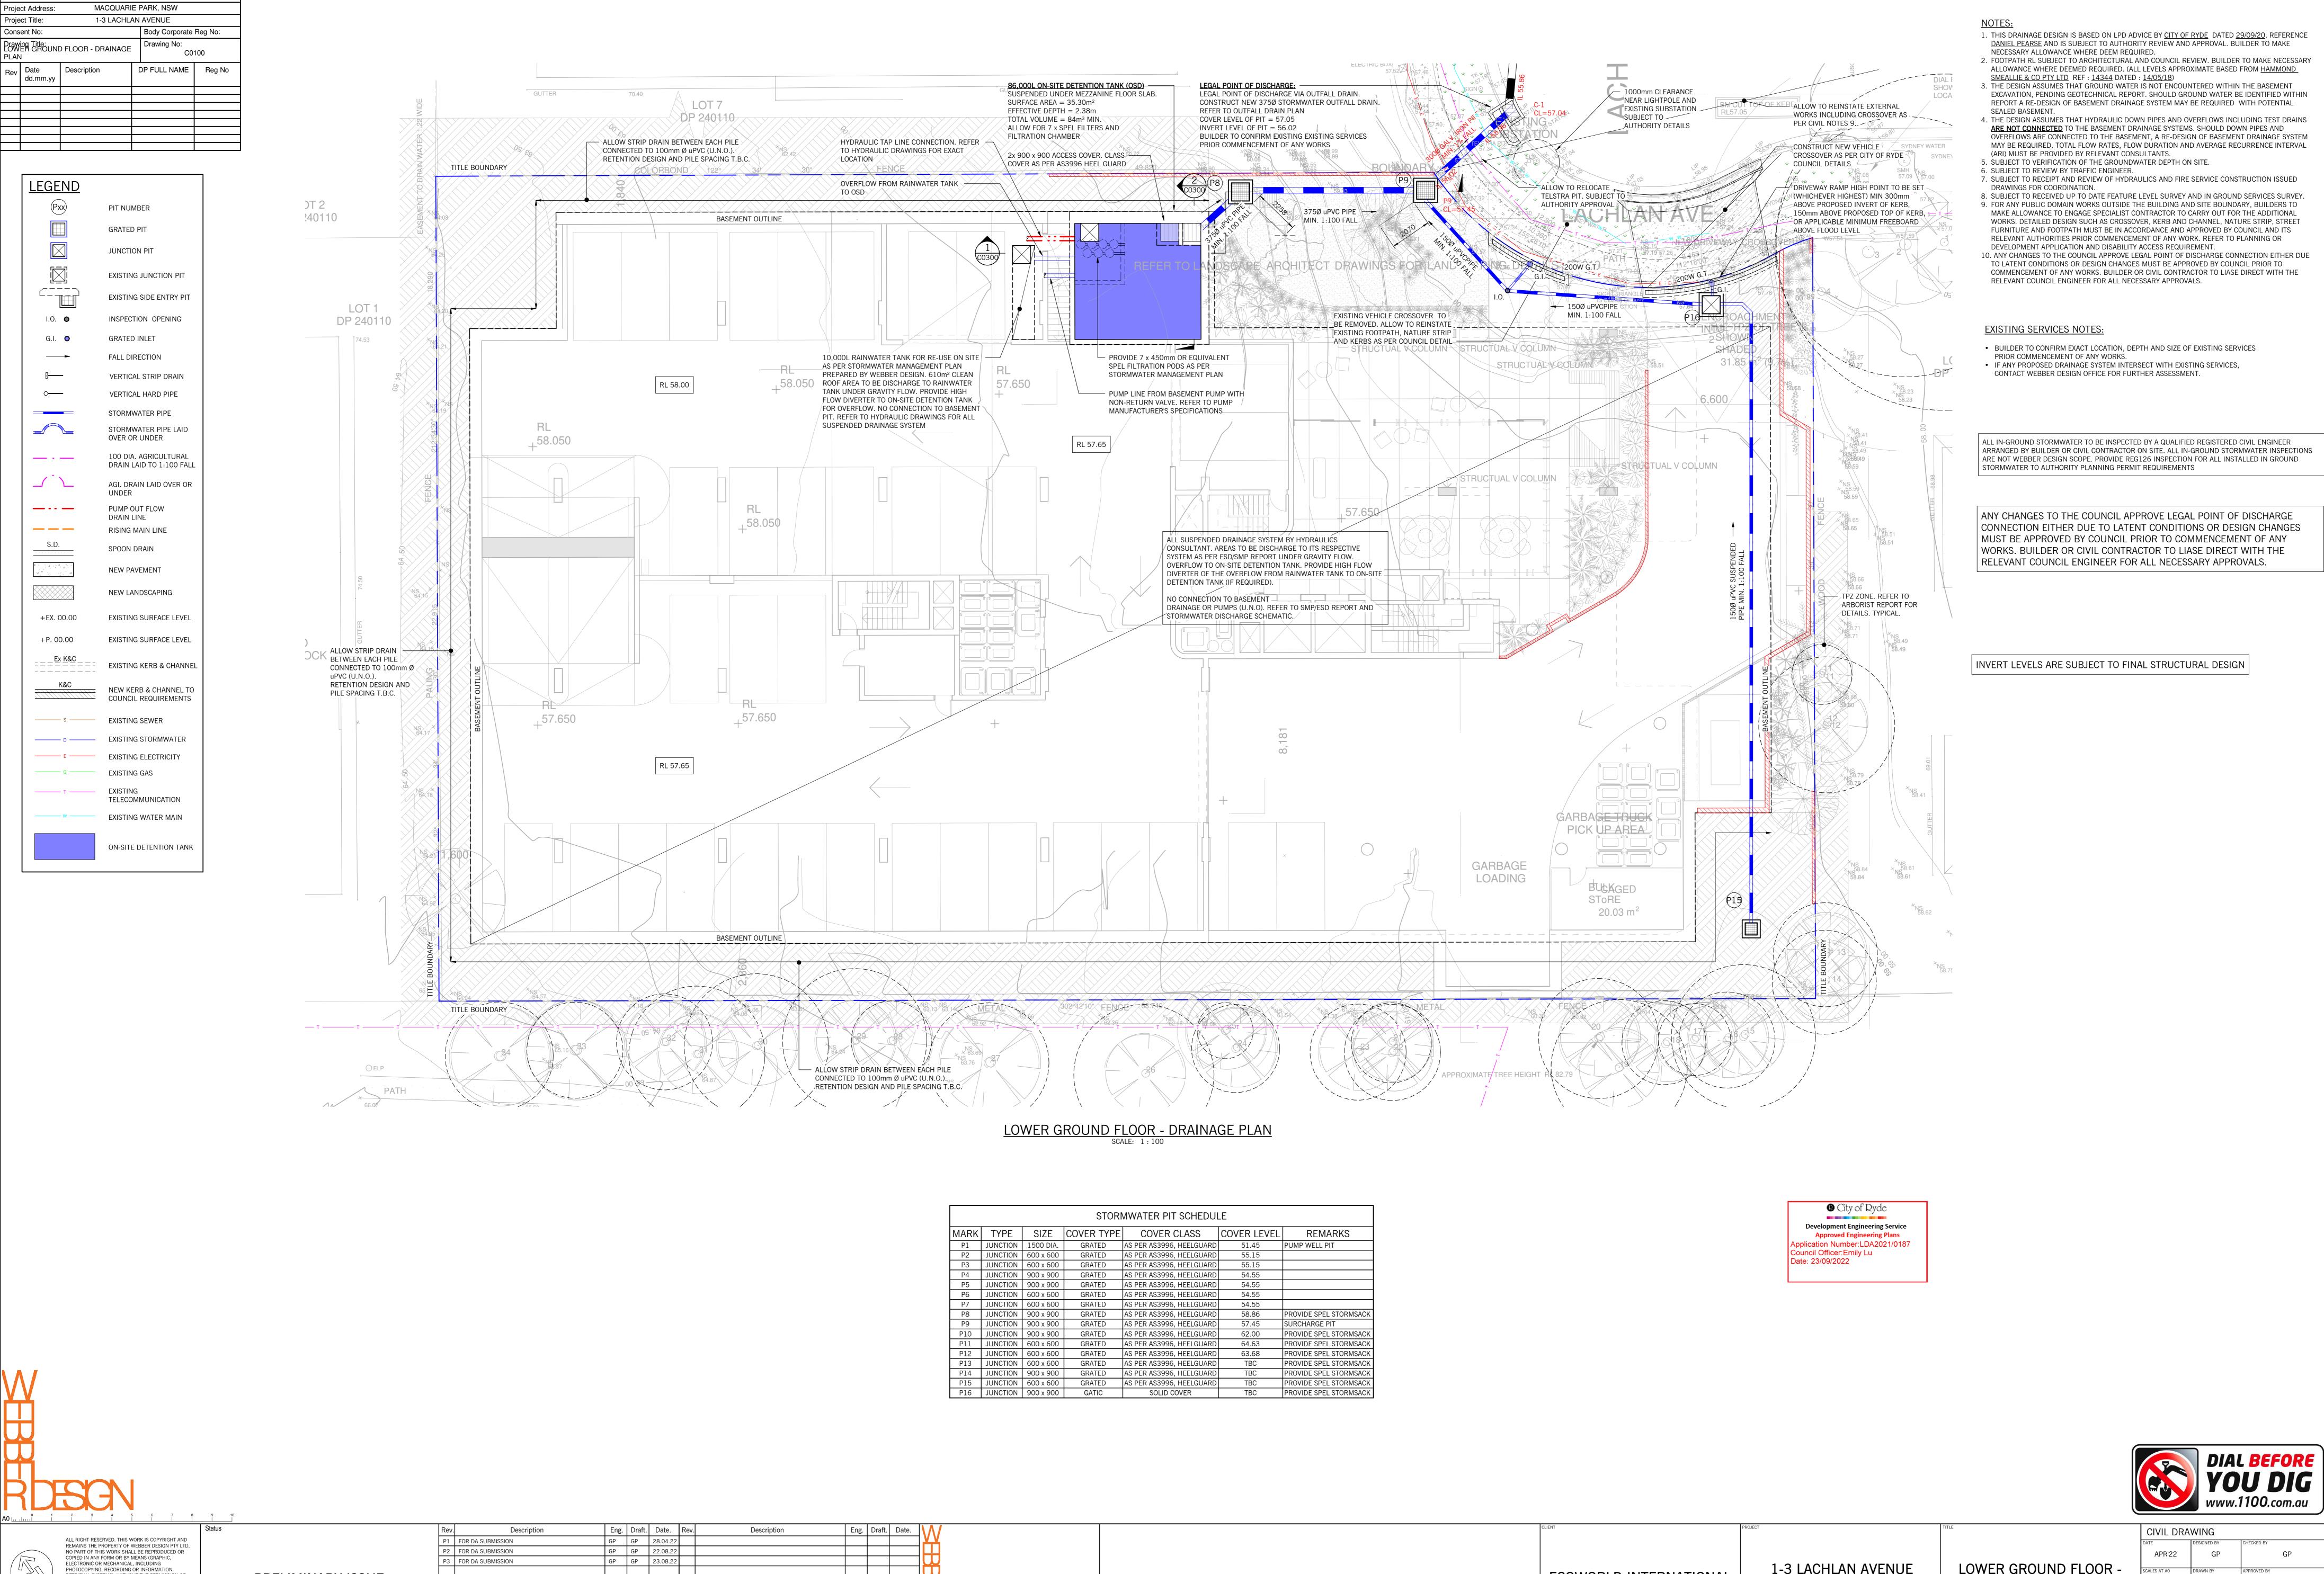
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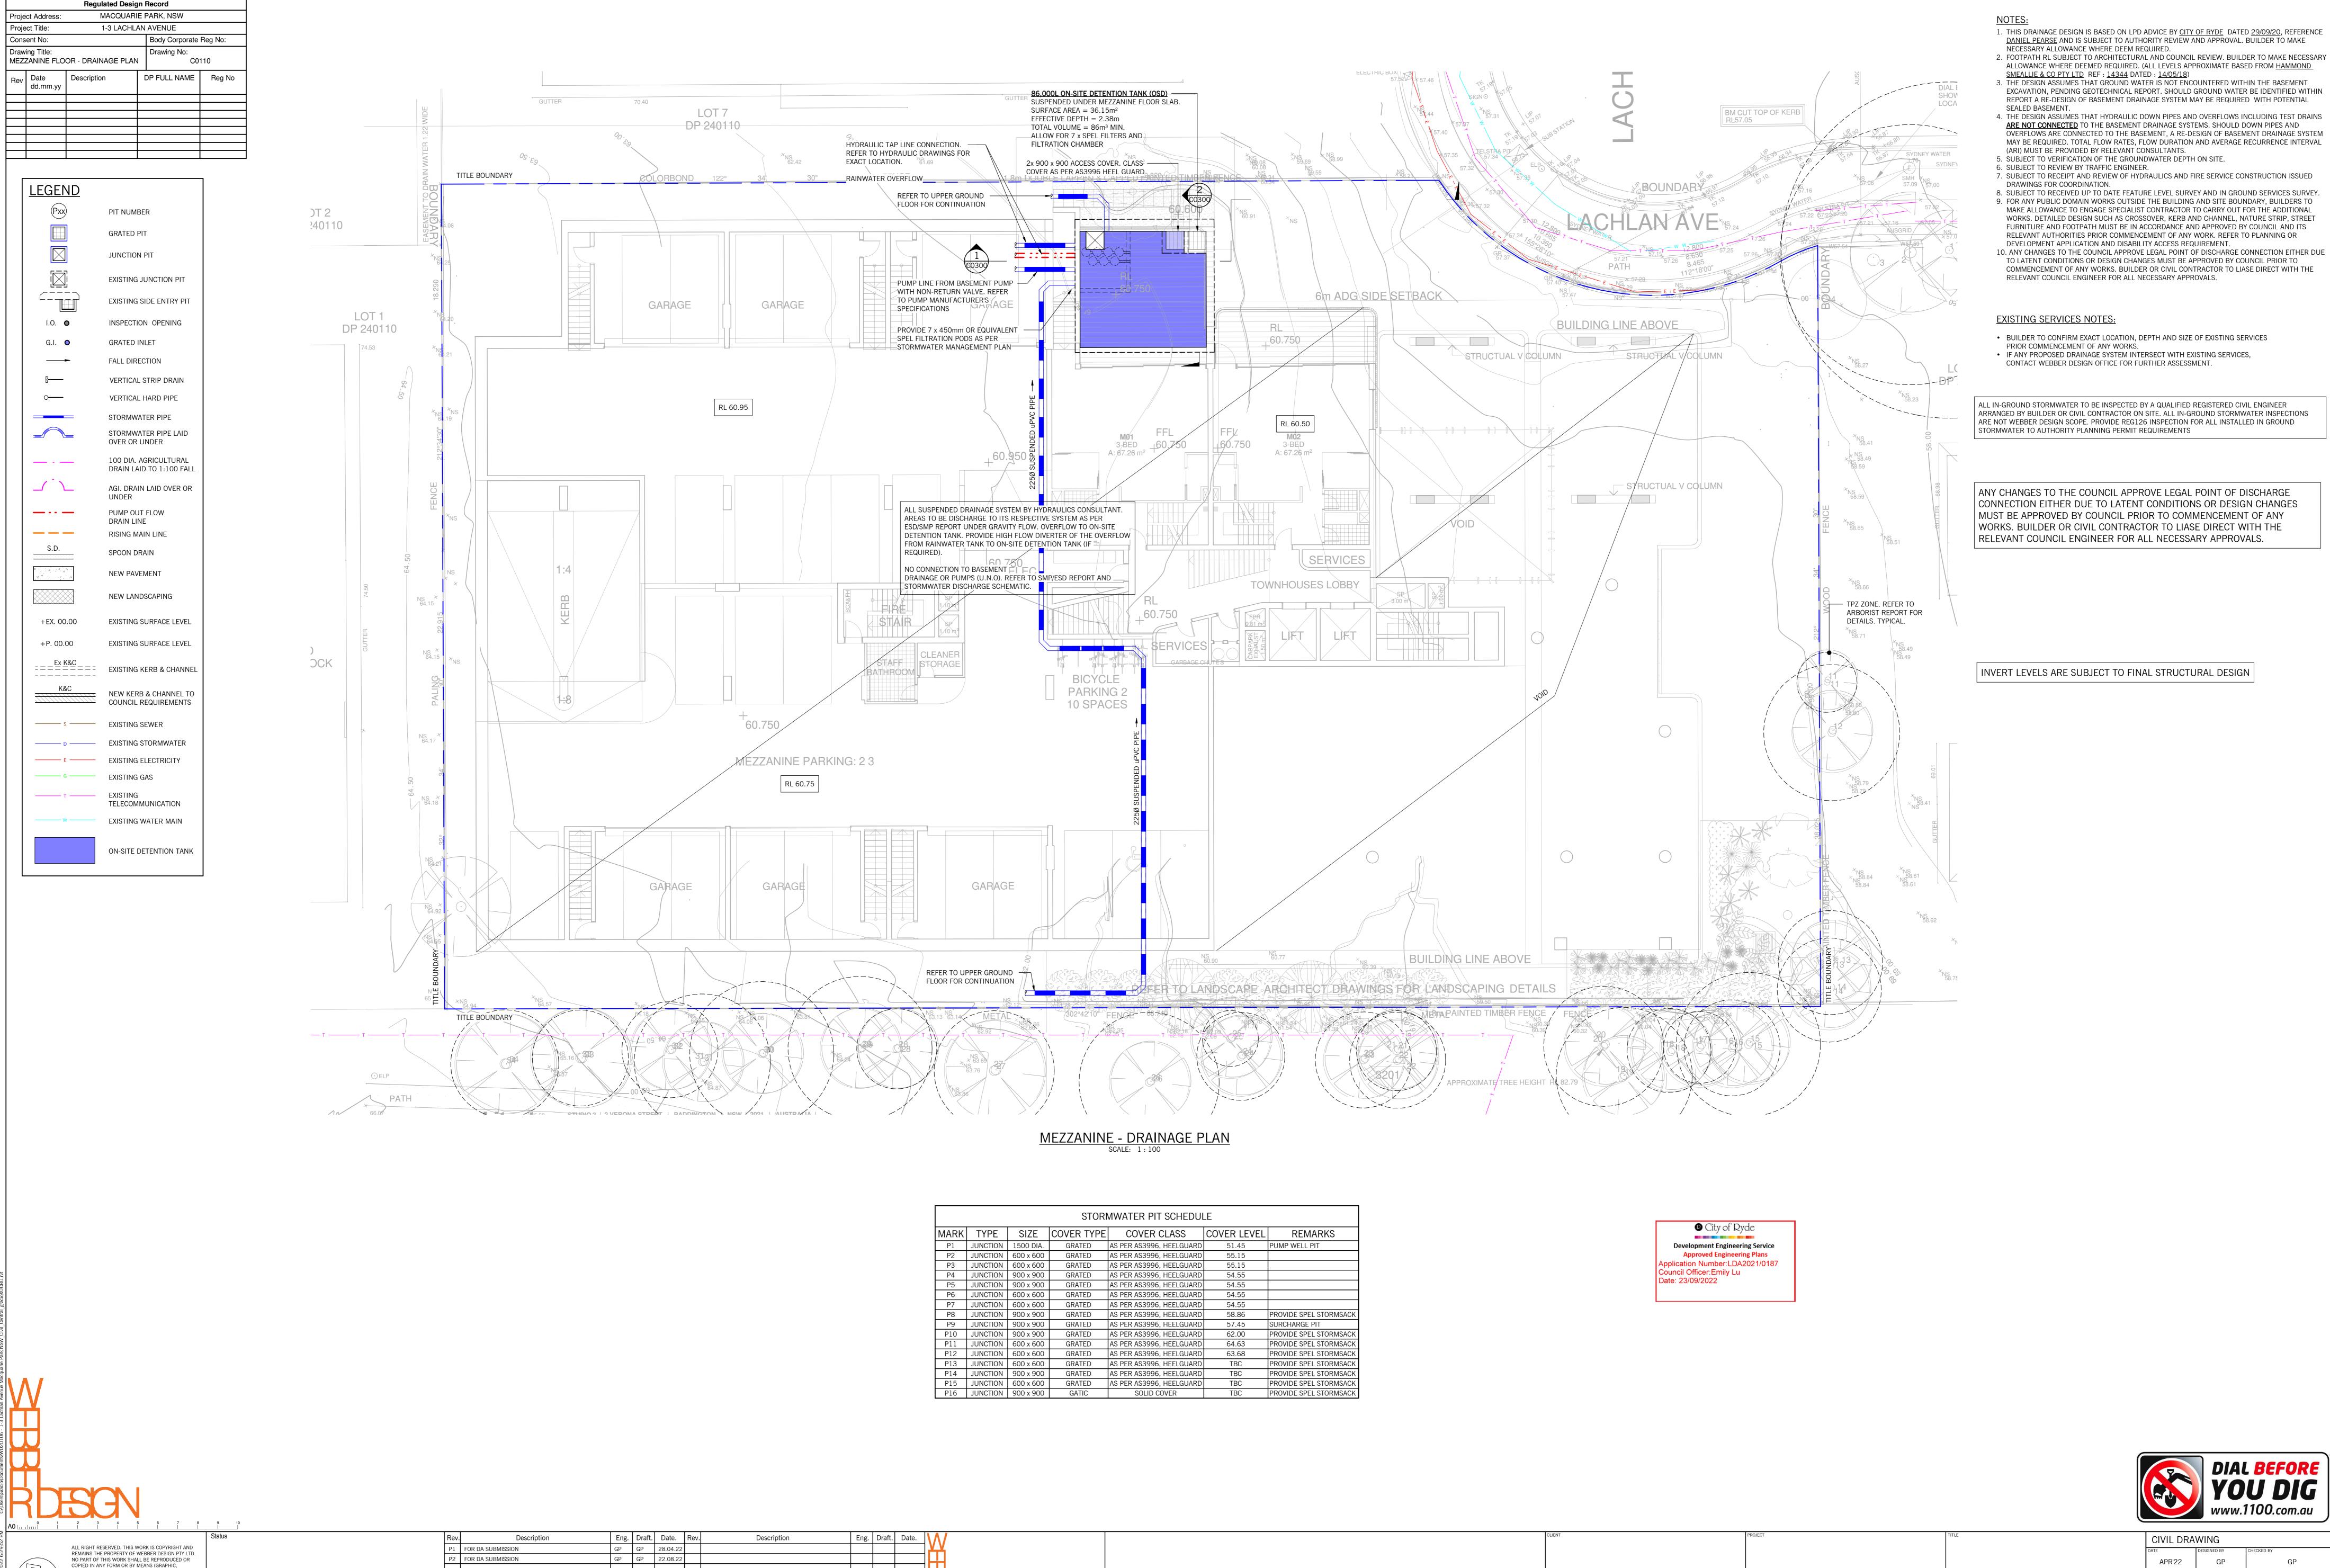
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LOWER GROUND FLOOR

DRAINAGE PLAN



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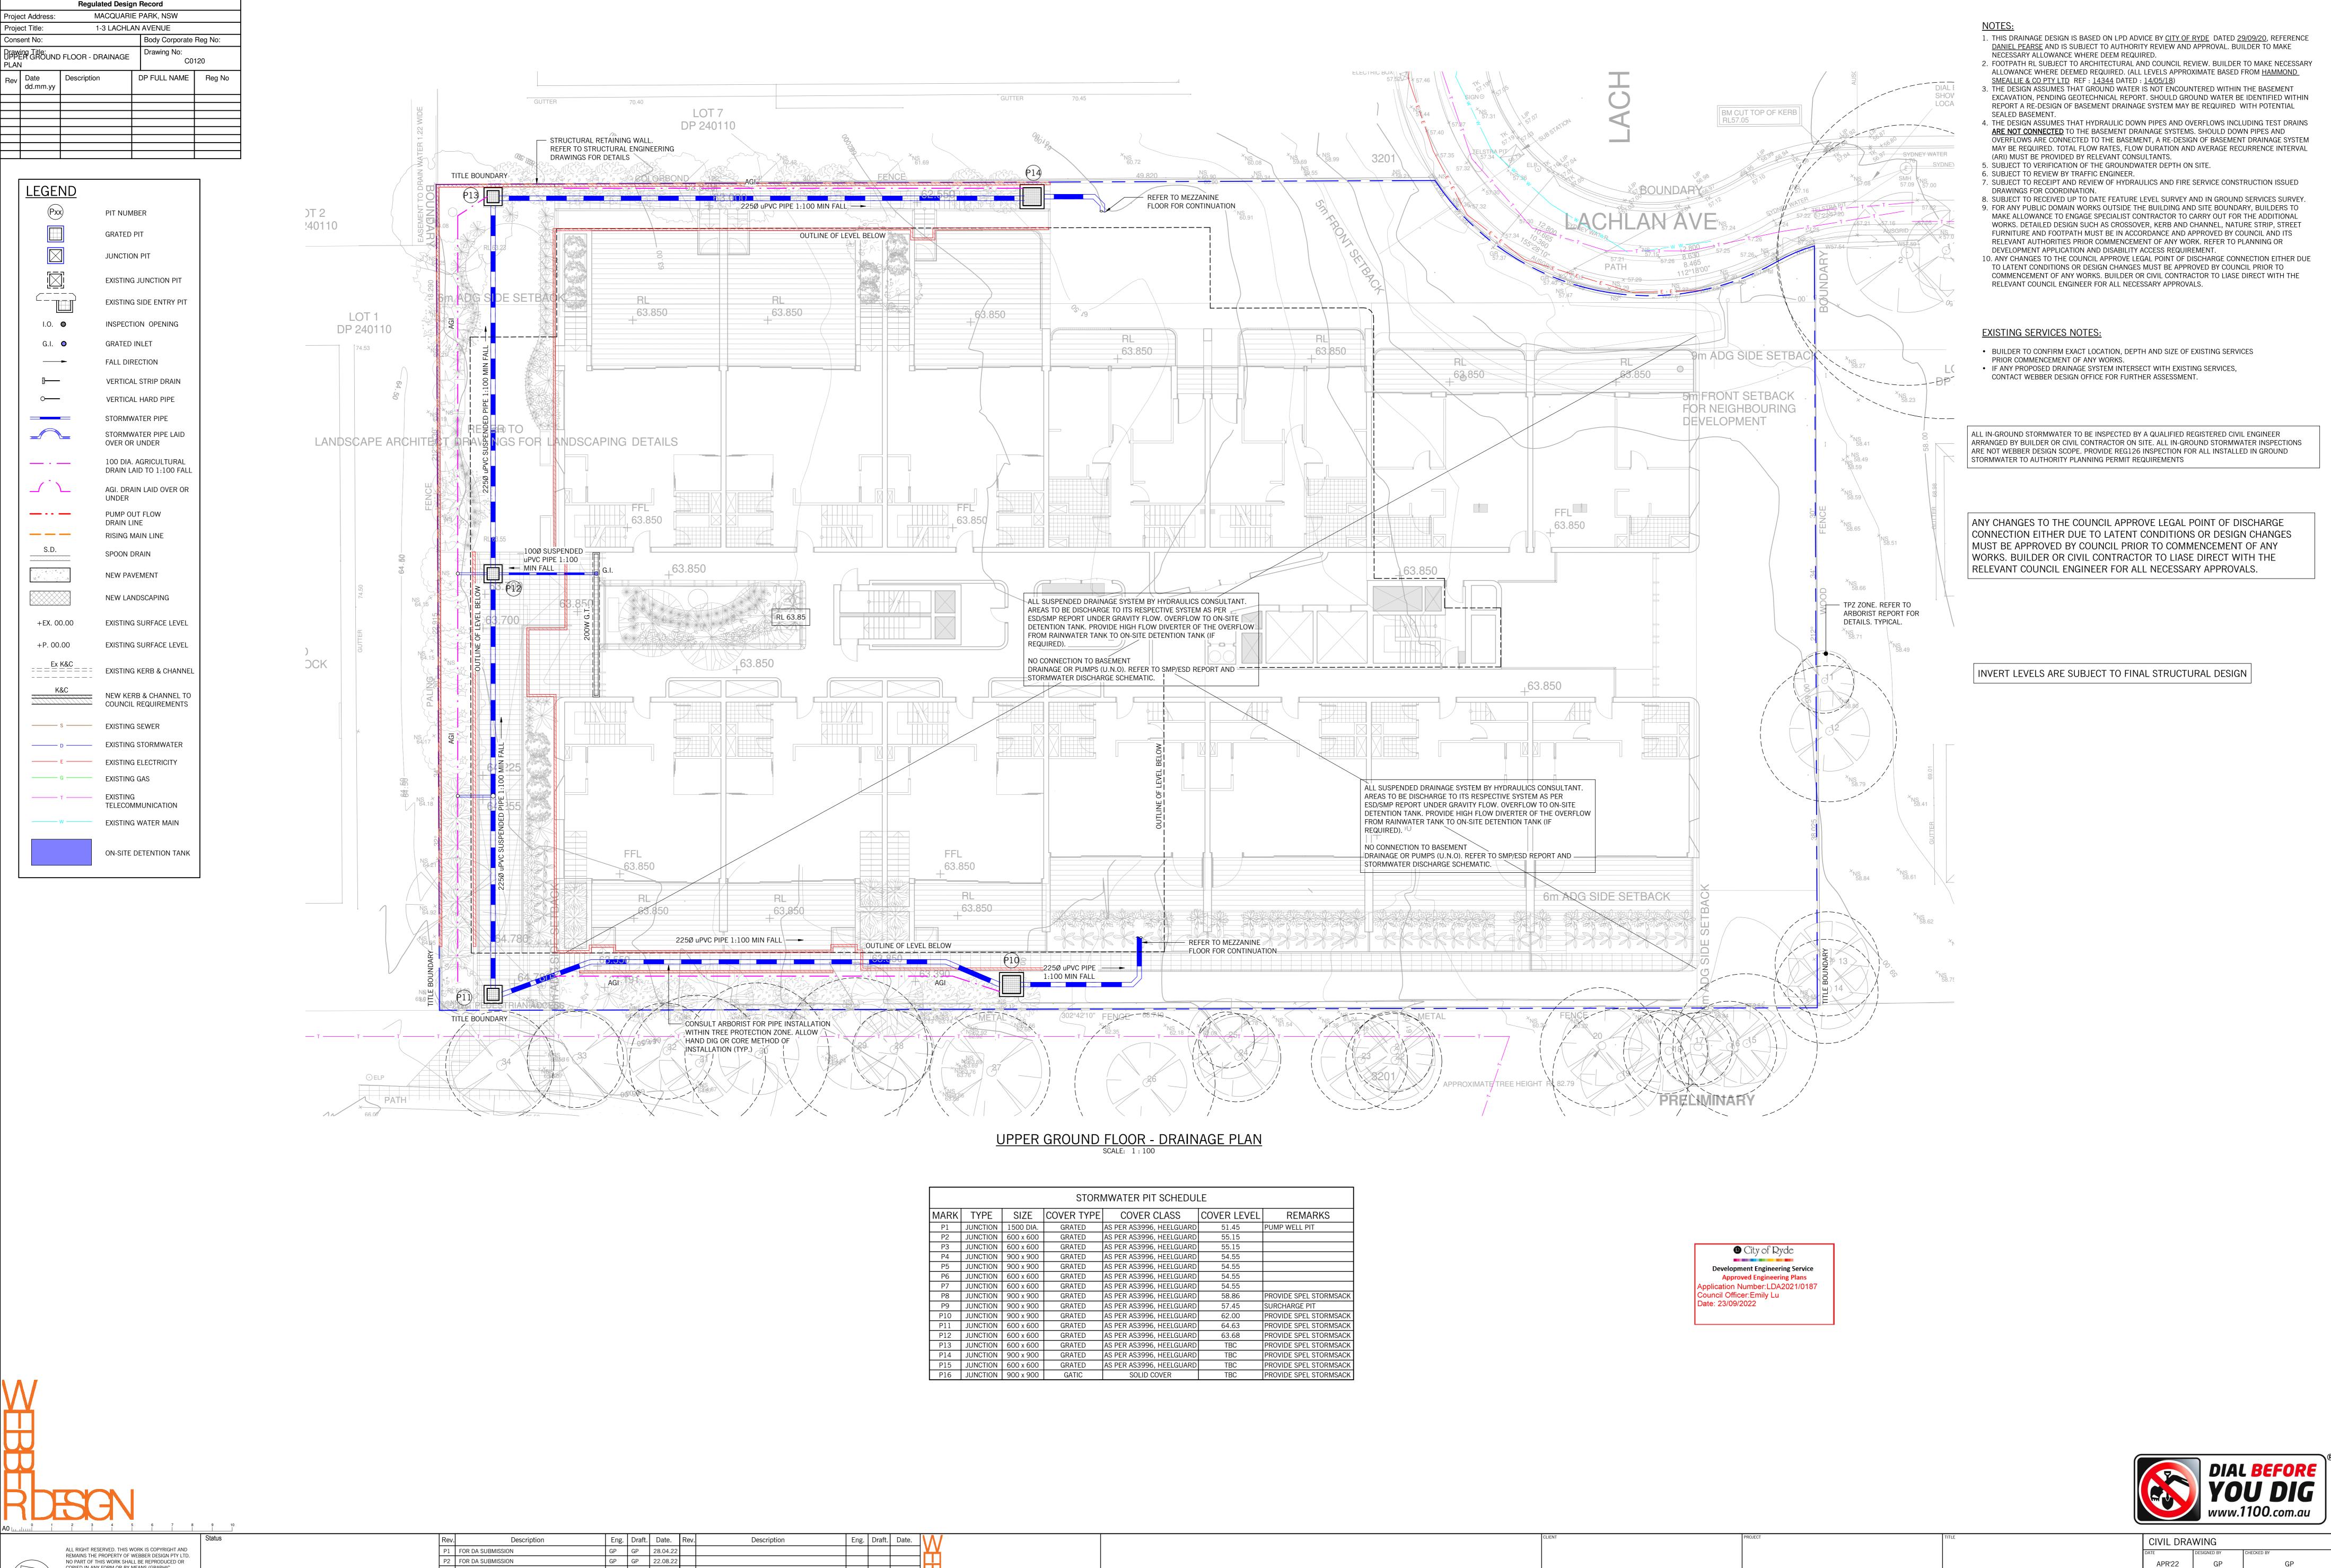
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MEZZANINE FLOOR -

DRAINAGE PLAN



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UPPER GROUND FLOOR DRAINAGE PLAN

APR'22

GP

GP

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GP

PW

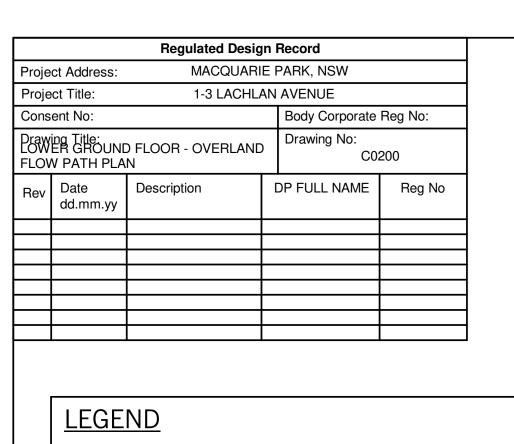
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DRAWING No.
C0120
P2

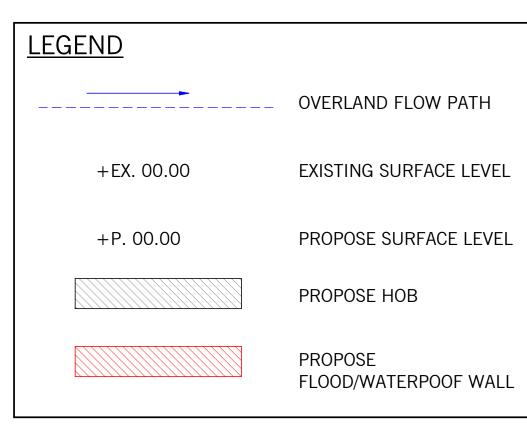
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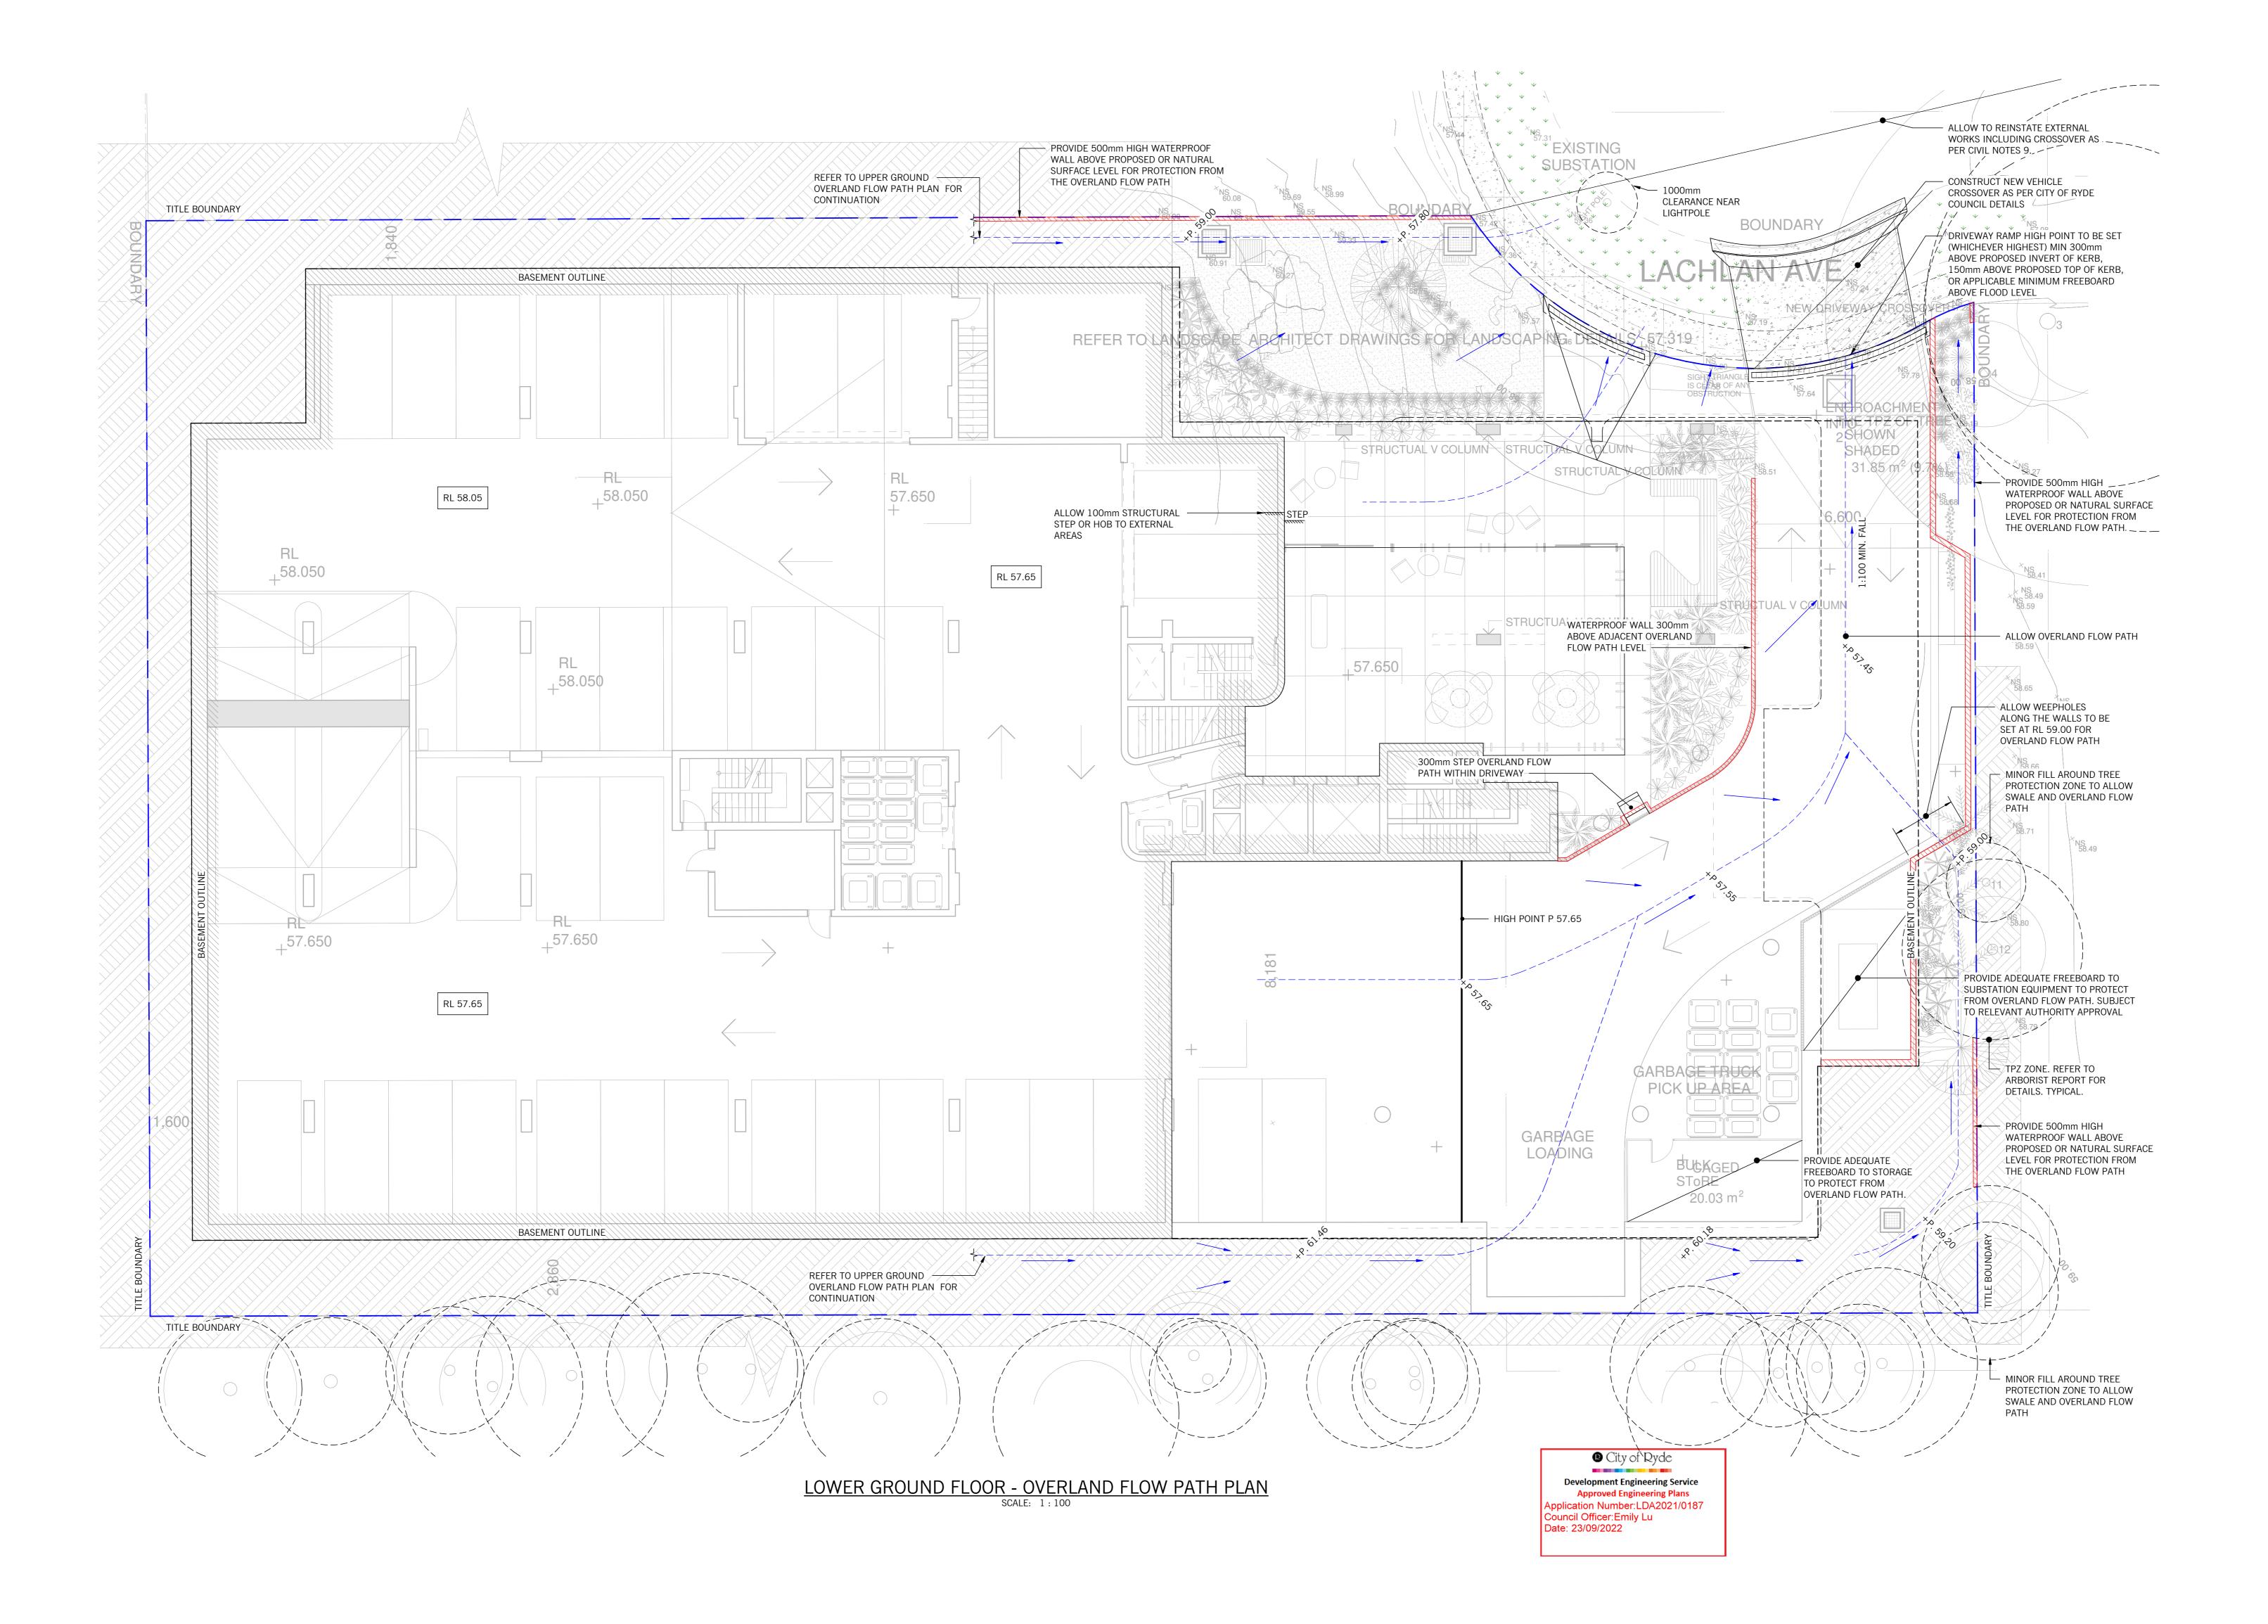
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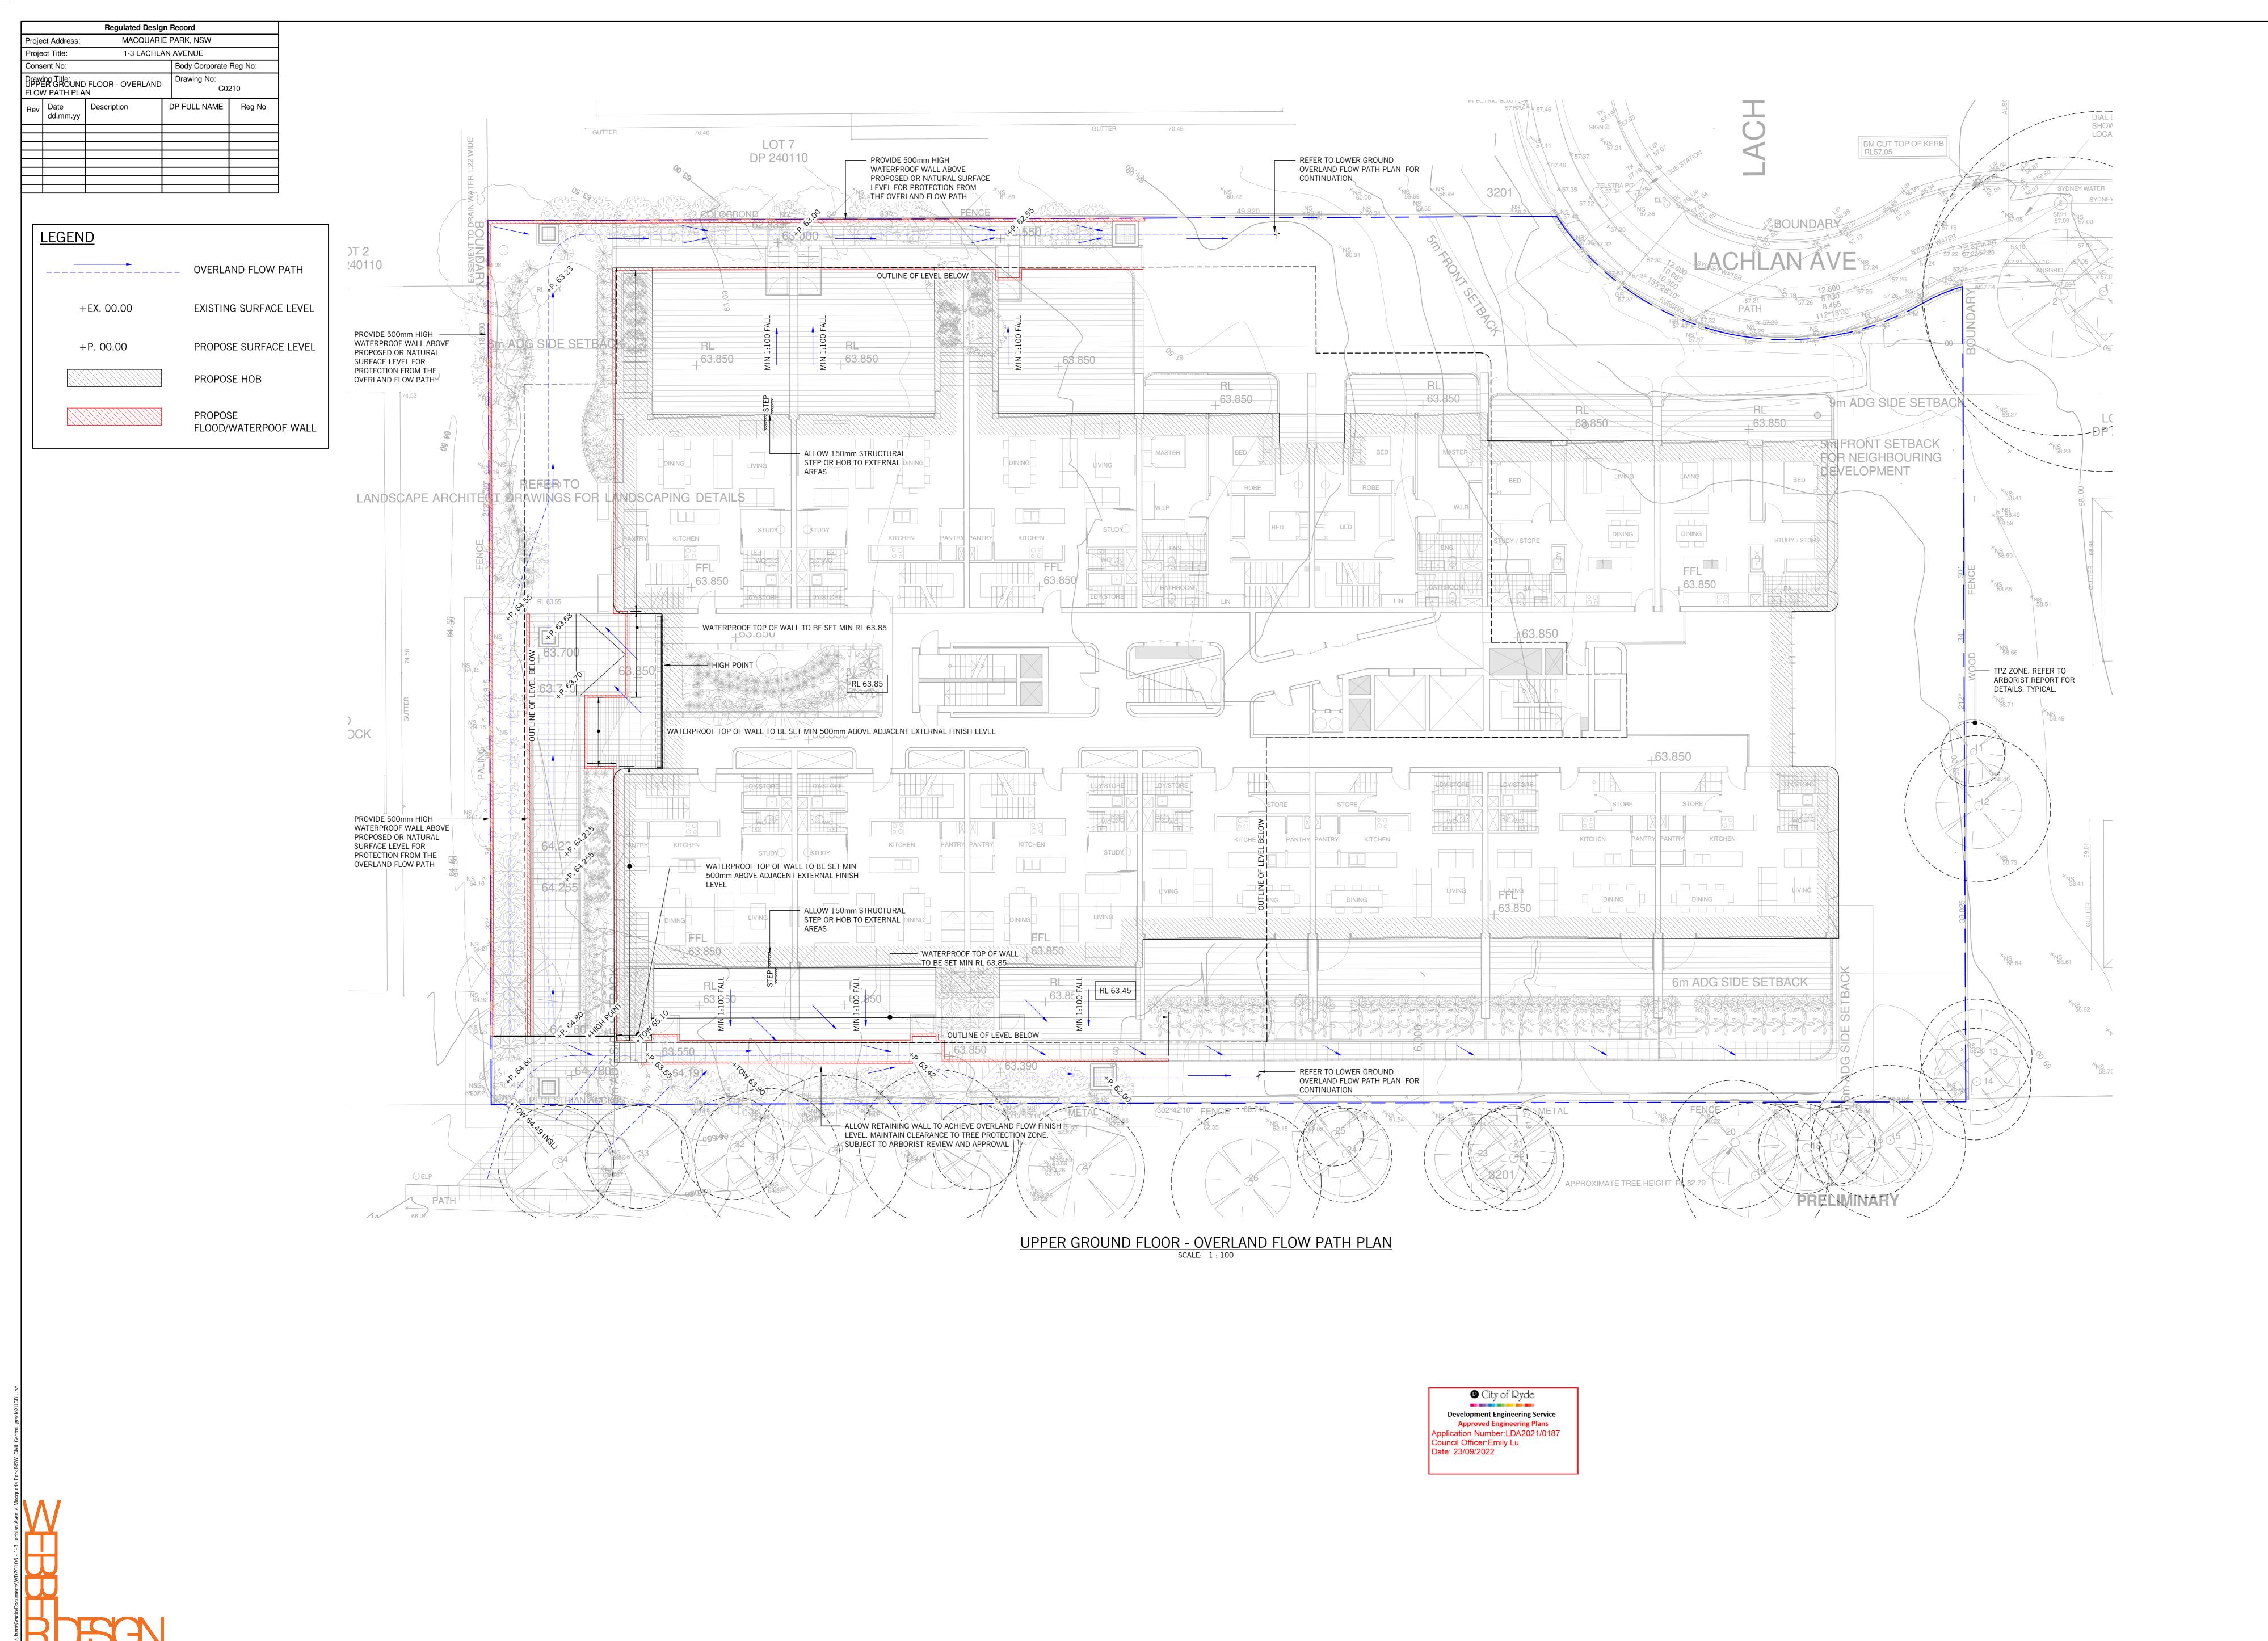
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1-3 LACHLAN AVENUE
MACQUARIE PARK, NSW

LOWER GROUND FLOOR -OVERLAND FLOW PATH PLAN

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DRAWN BY	APPROVED BY				
GP	PW				
		1			
DRAWING No.		REV.			
C02	P3				
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UPPER GROUND FLOOR 1-3 LACHLAN AVENUE OVERLAND FLOW PATH MACQUARIE PARK, NSW PLAN

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